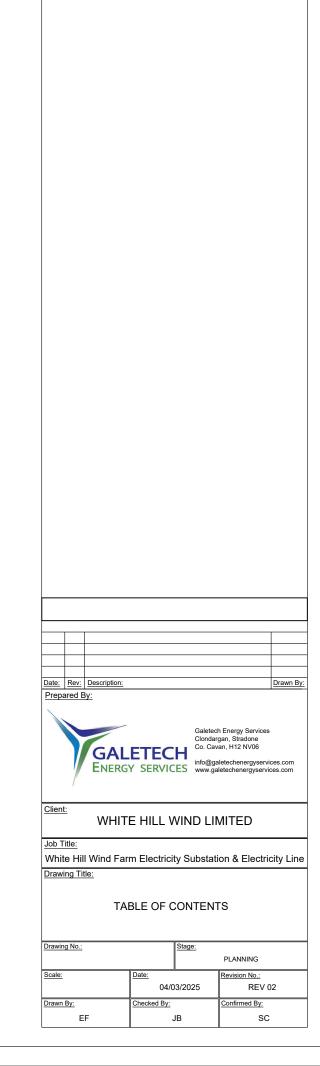
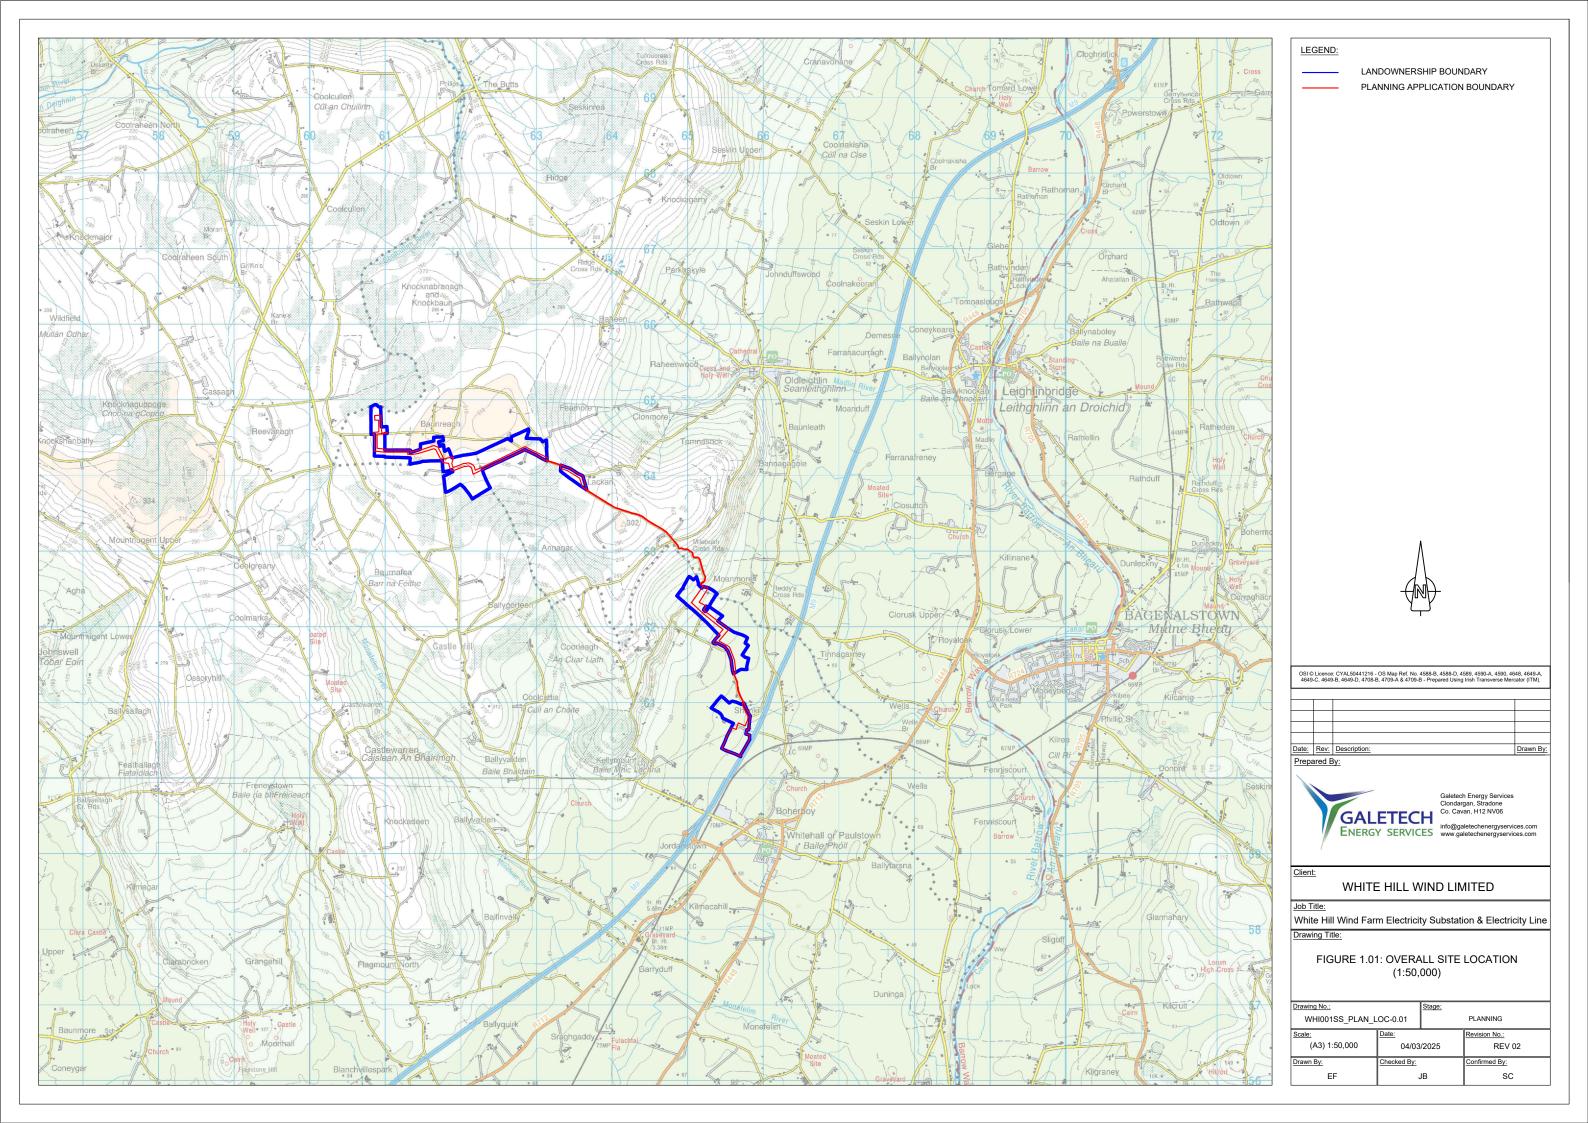
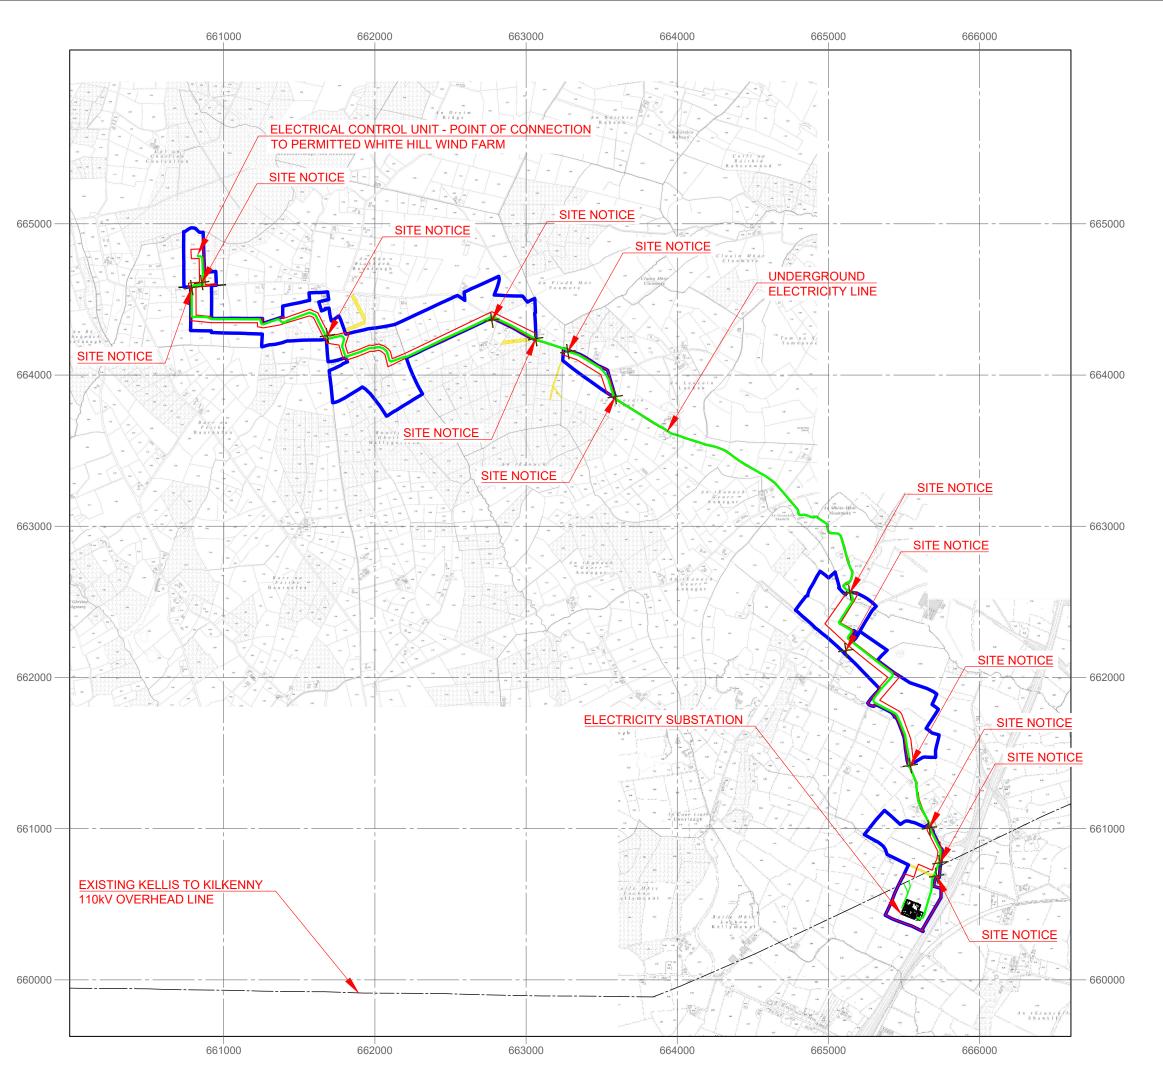
WHITE HILL WIND FARM ELECTRICITY SUBSTATION & ELECTRICITY LINE PLANNING DRAWINGS

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LEGEND: LANDOWNERSHIP BOUNDARY PLANNING APPLICATION BOUNDARY UNDERGROUND ELECTRICITY LINE EXISTING WAYLEAVE SPOT HEIGHT **+**68.559

NOTES:

- ALL DIMENSIONS MUST BE CHECKED ON SITE AND NOT SCALED FROM THIS DRAWING.
- ALL DIMENSIONS IN METRES UNLESS OTHERWISE STATED.
- STATED.

 3. DIMENSIONS MAY IMMATERIALLY VARY DEPENDING ON SITE CONDITIONS.

 4. WHILE THE PRECISE SITING OF INFRASTRUCTURE MAY IMMATERIALLY DEVIATE FROM THAT ILLUSTRATED, ALL INFRASTRUCTURE SHALL BE LOCATED WITHIN THE APPLICATION BOUNDARY.



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Date: Rev: Description

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Client:

WHITE HILL WIND LIMITED


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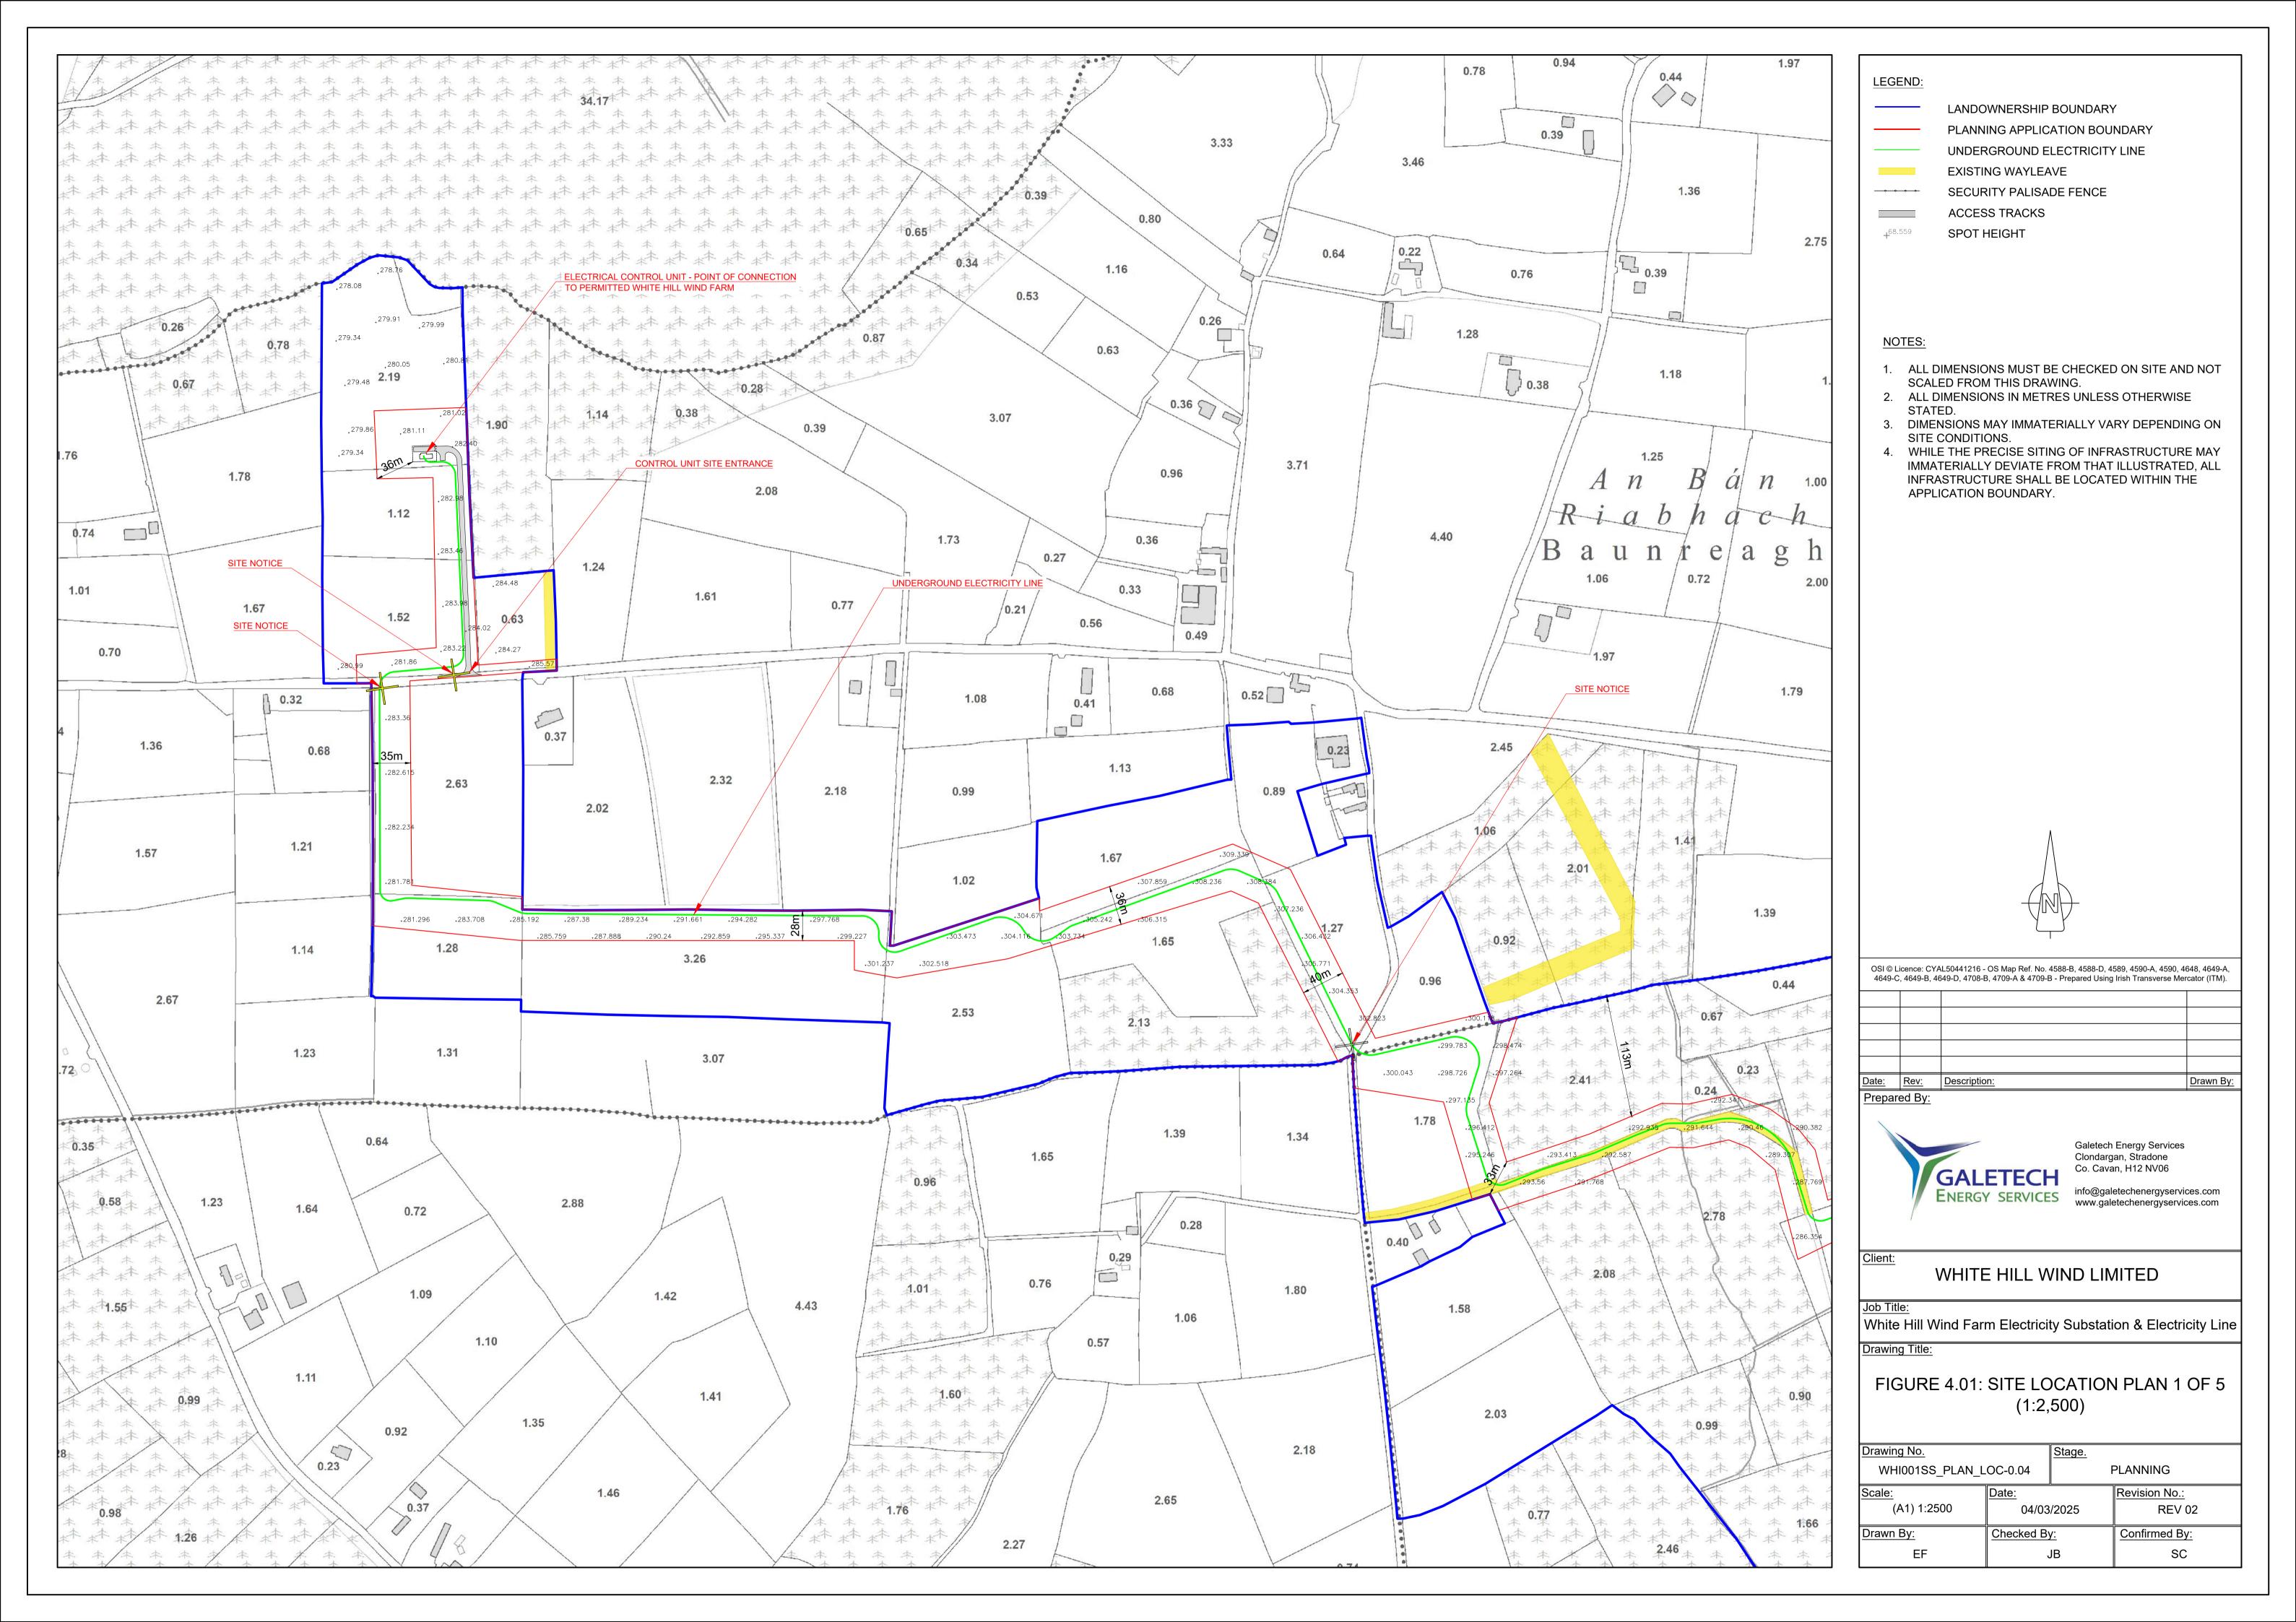
White Hill Wind Farm Electricity Substation & Electricity Line


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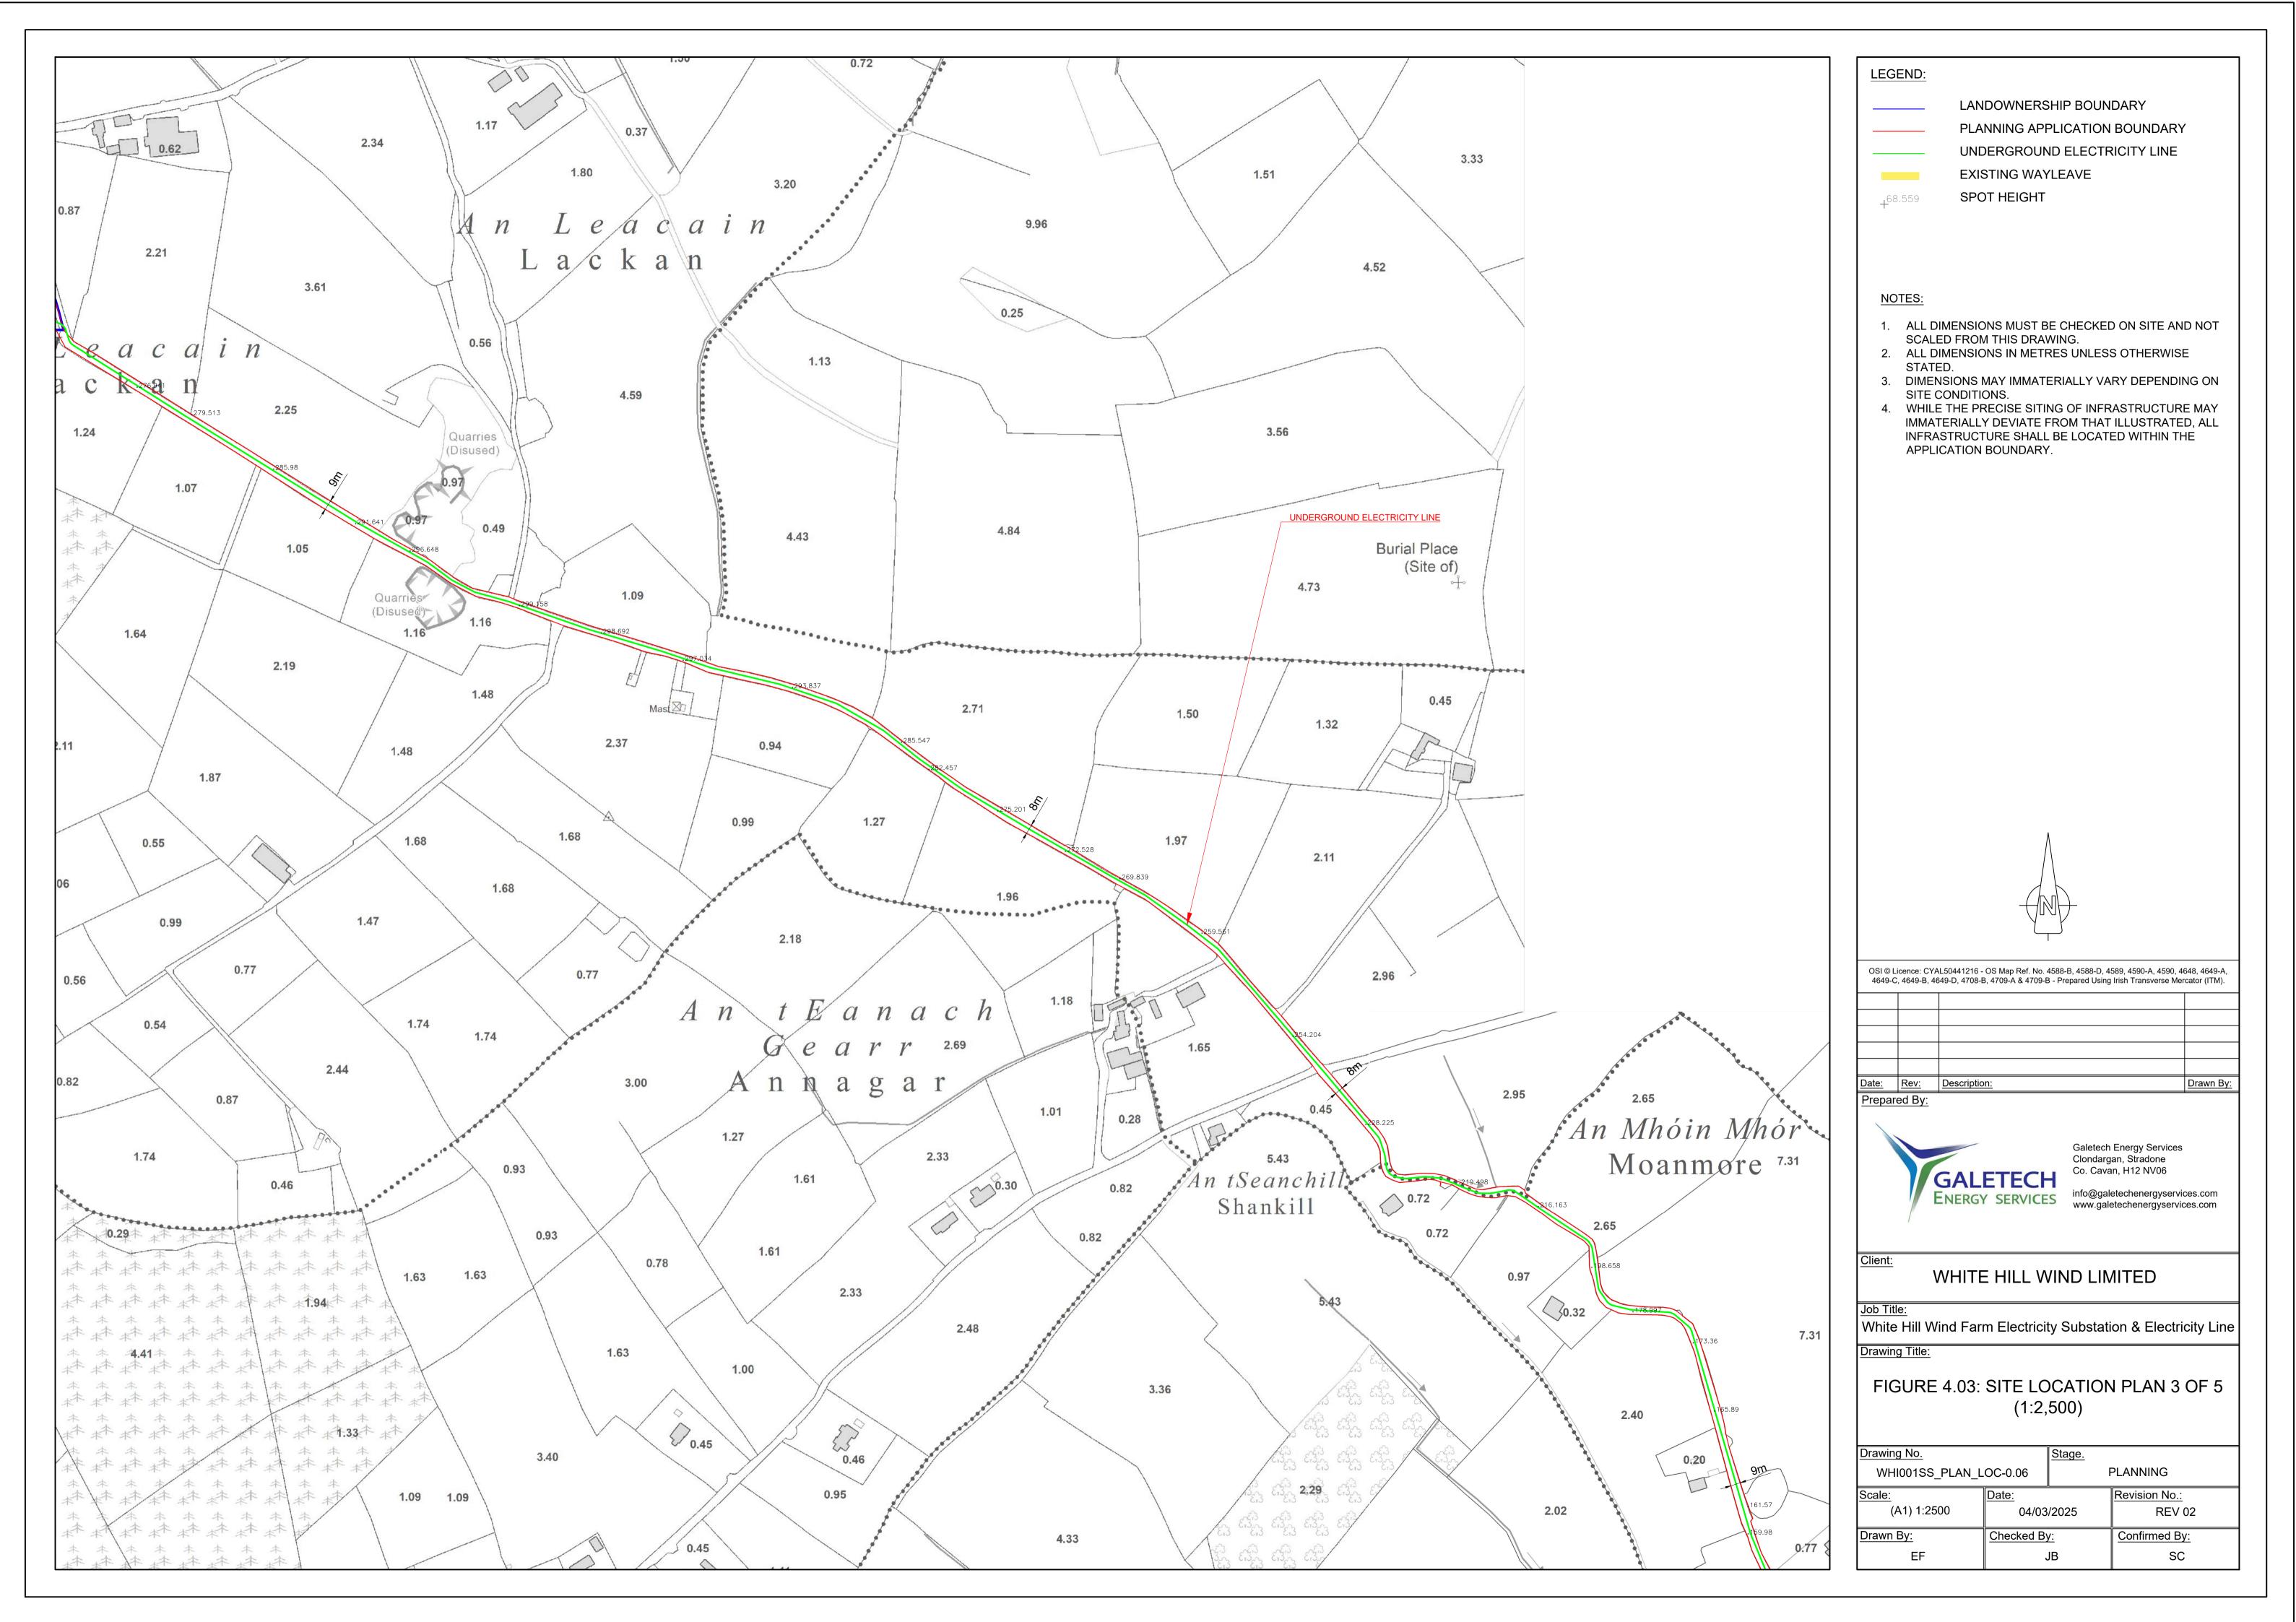
FIGURE 2.01: SITE LOCATION PLAN (1:25,000)


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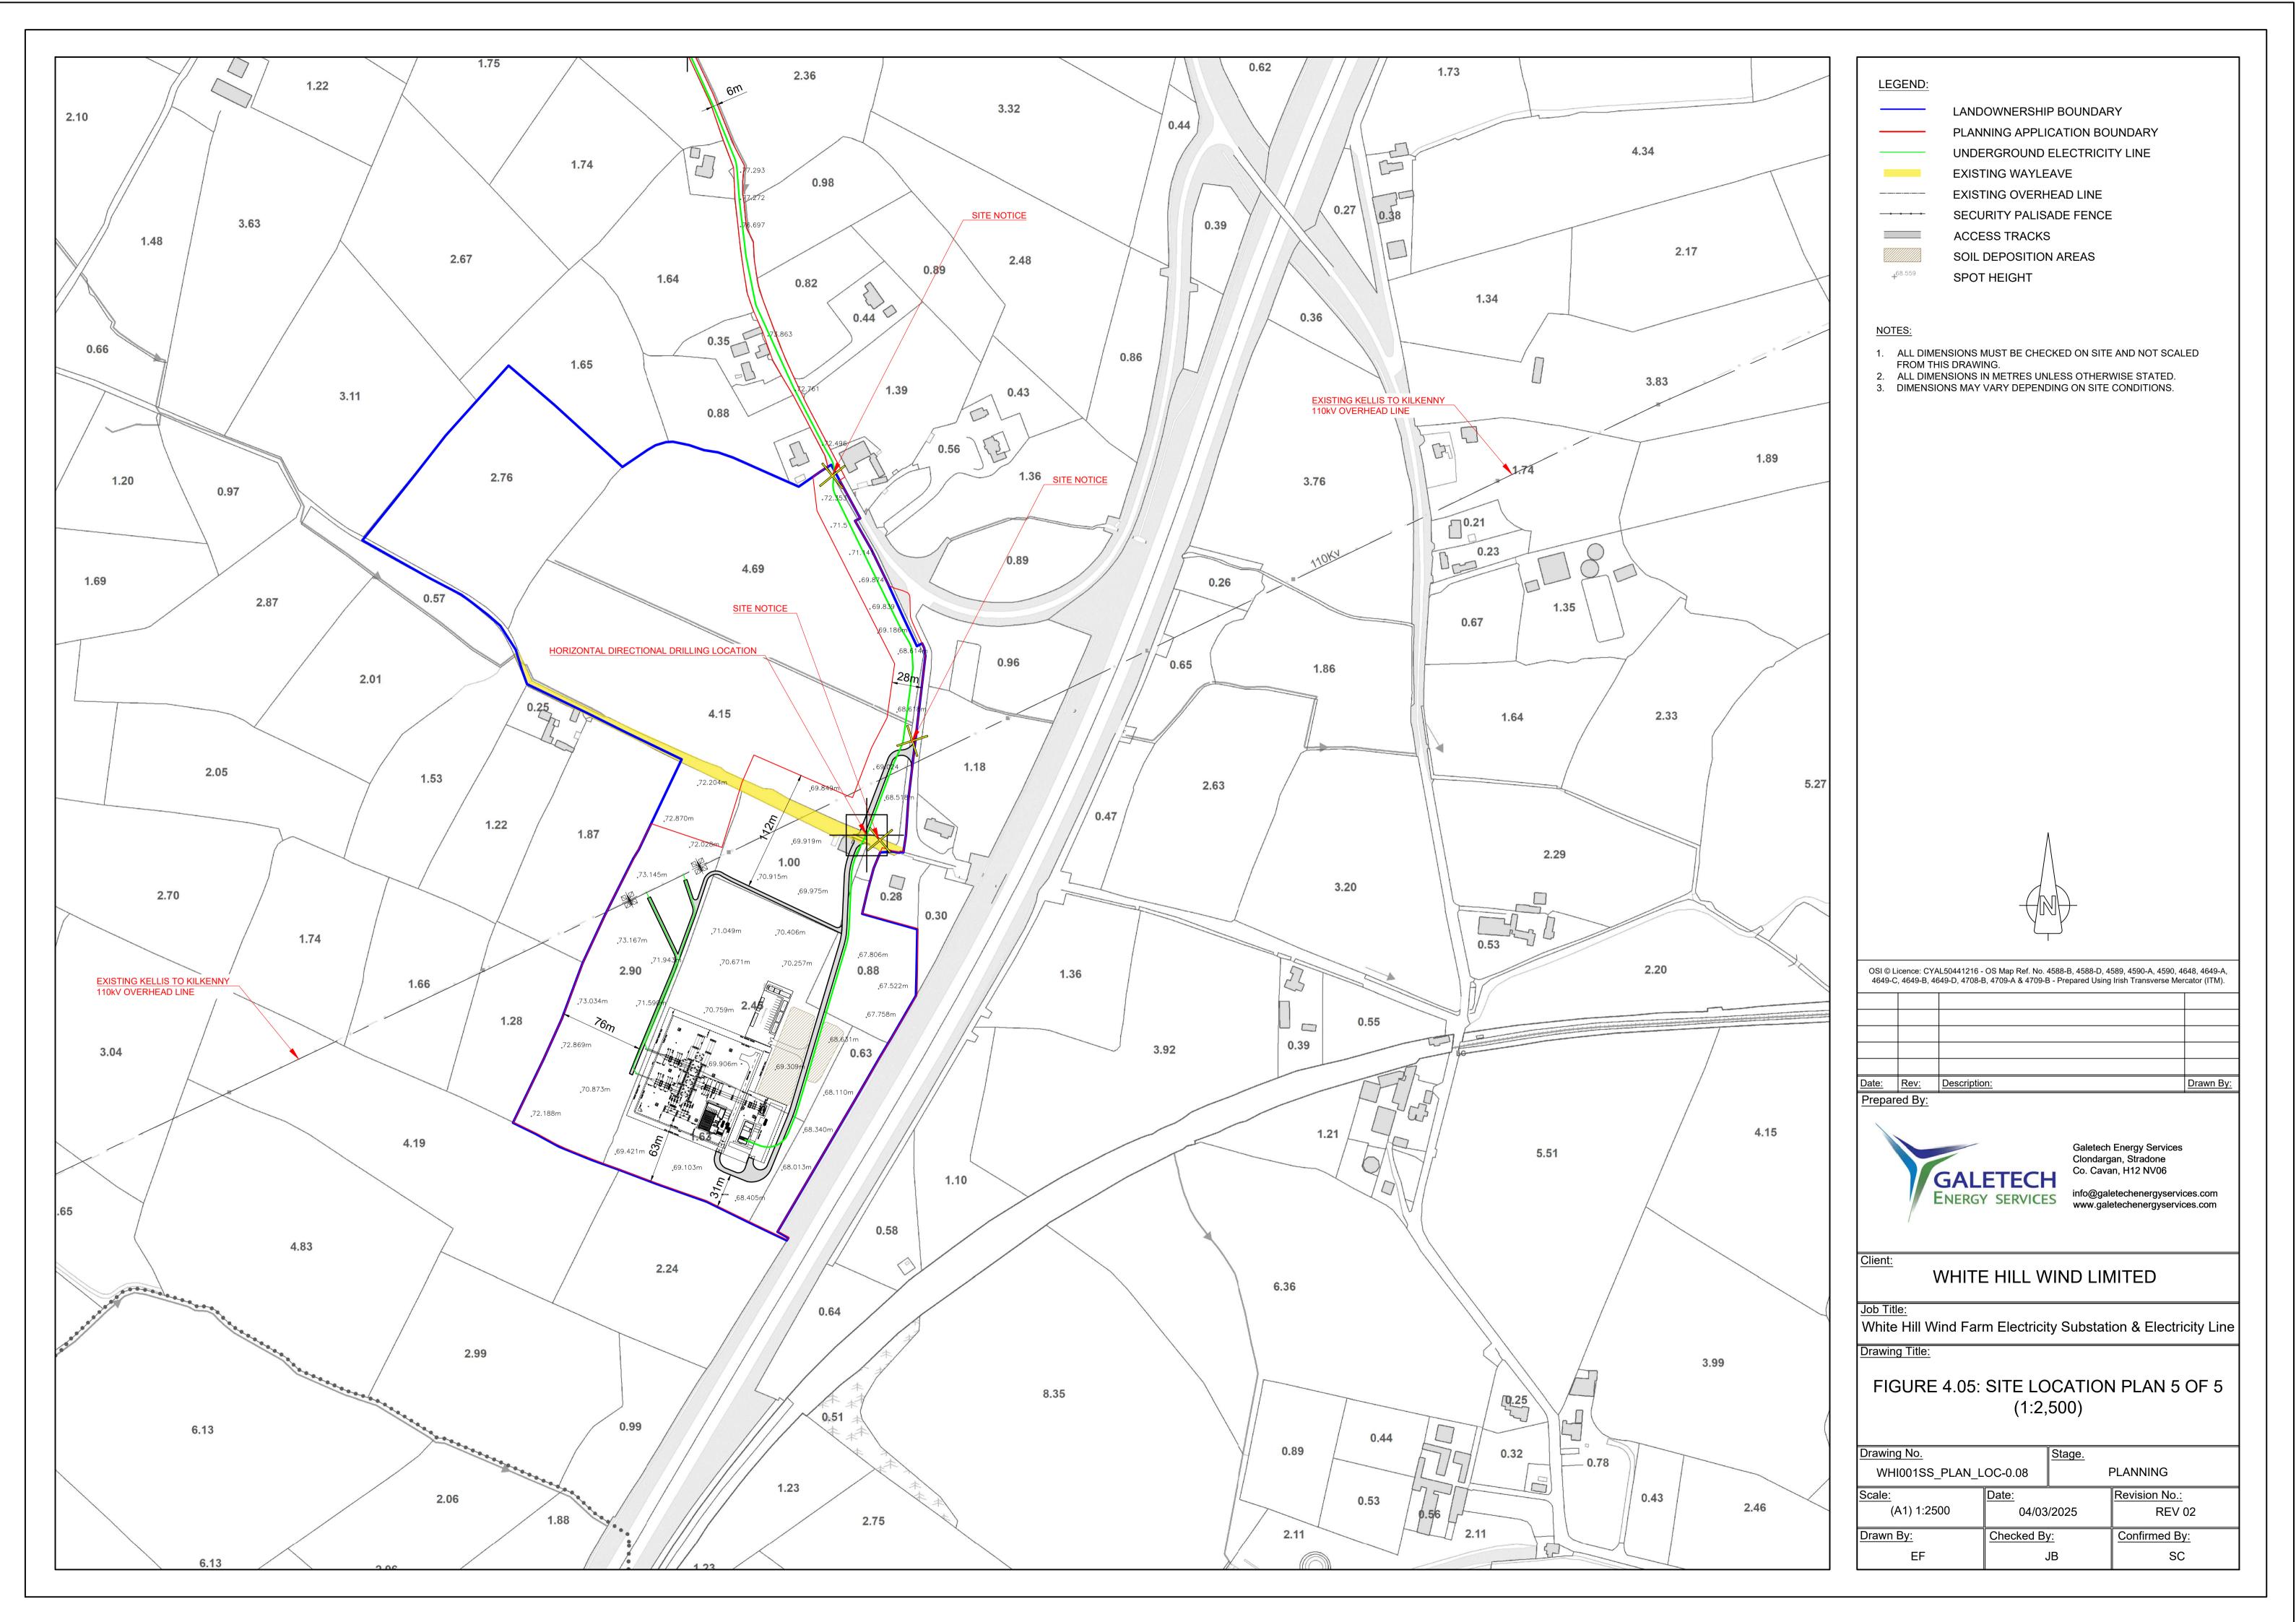








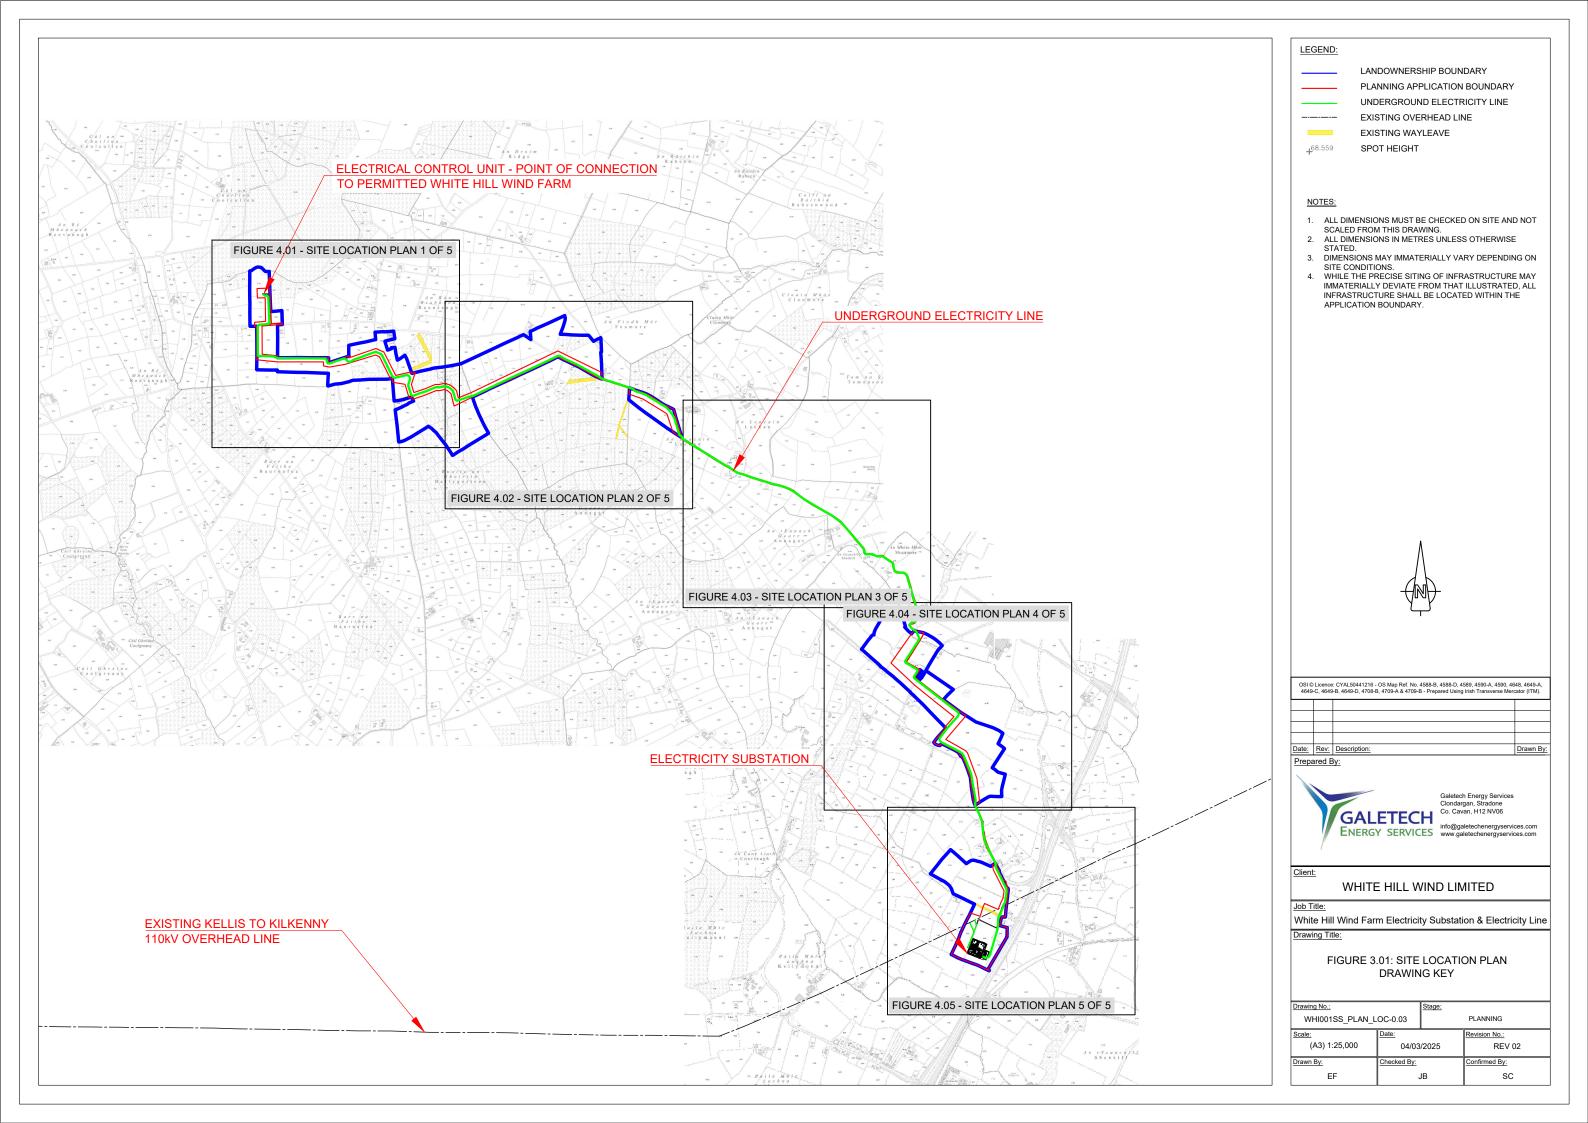


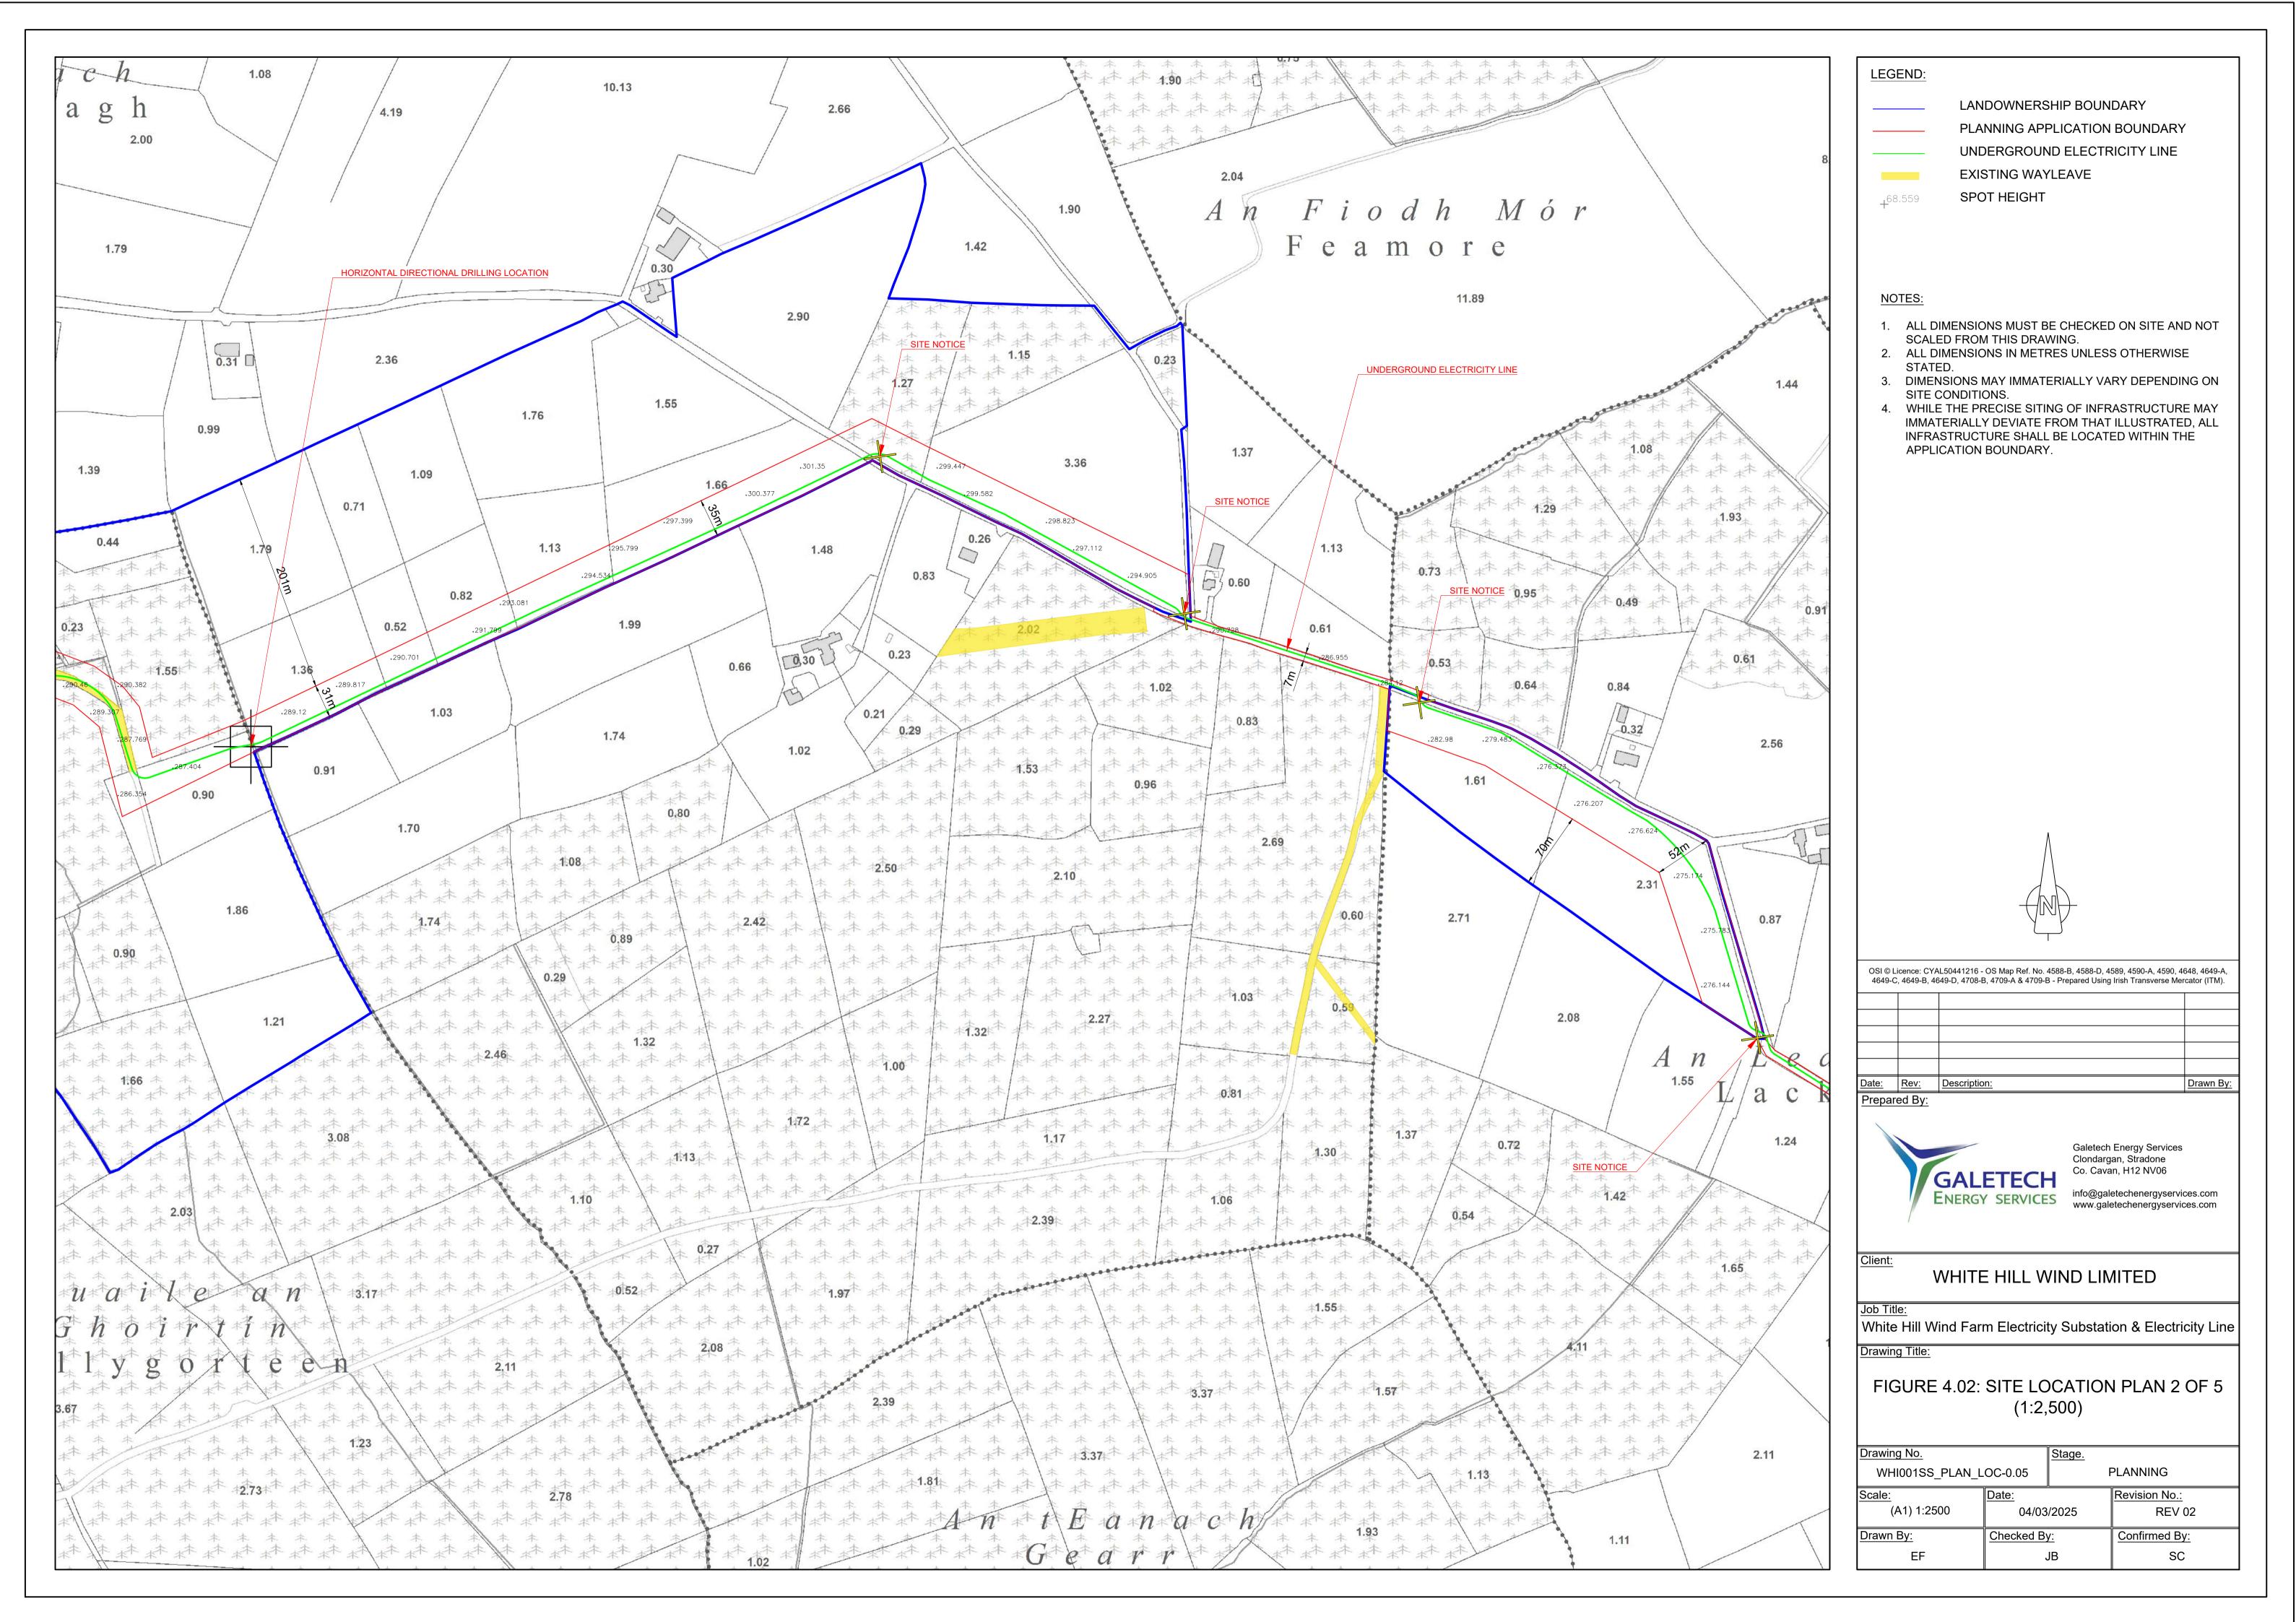


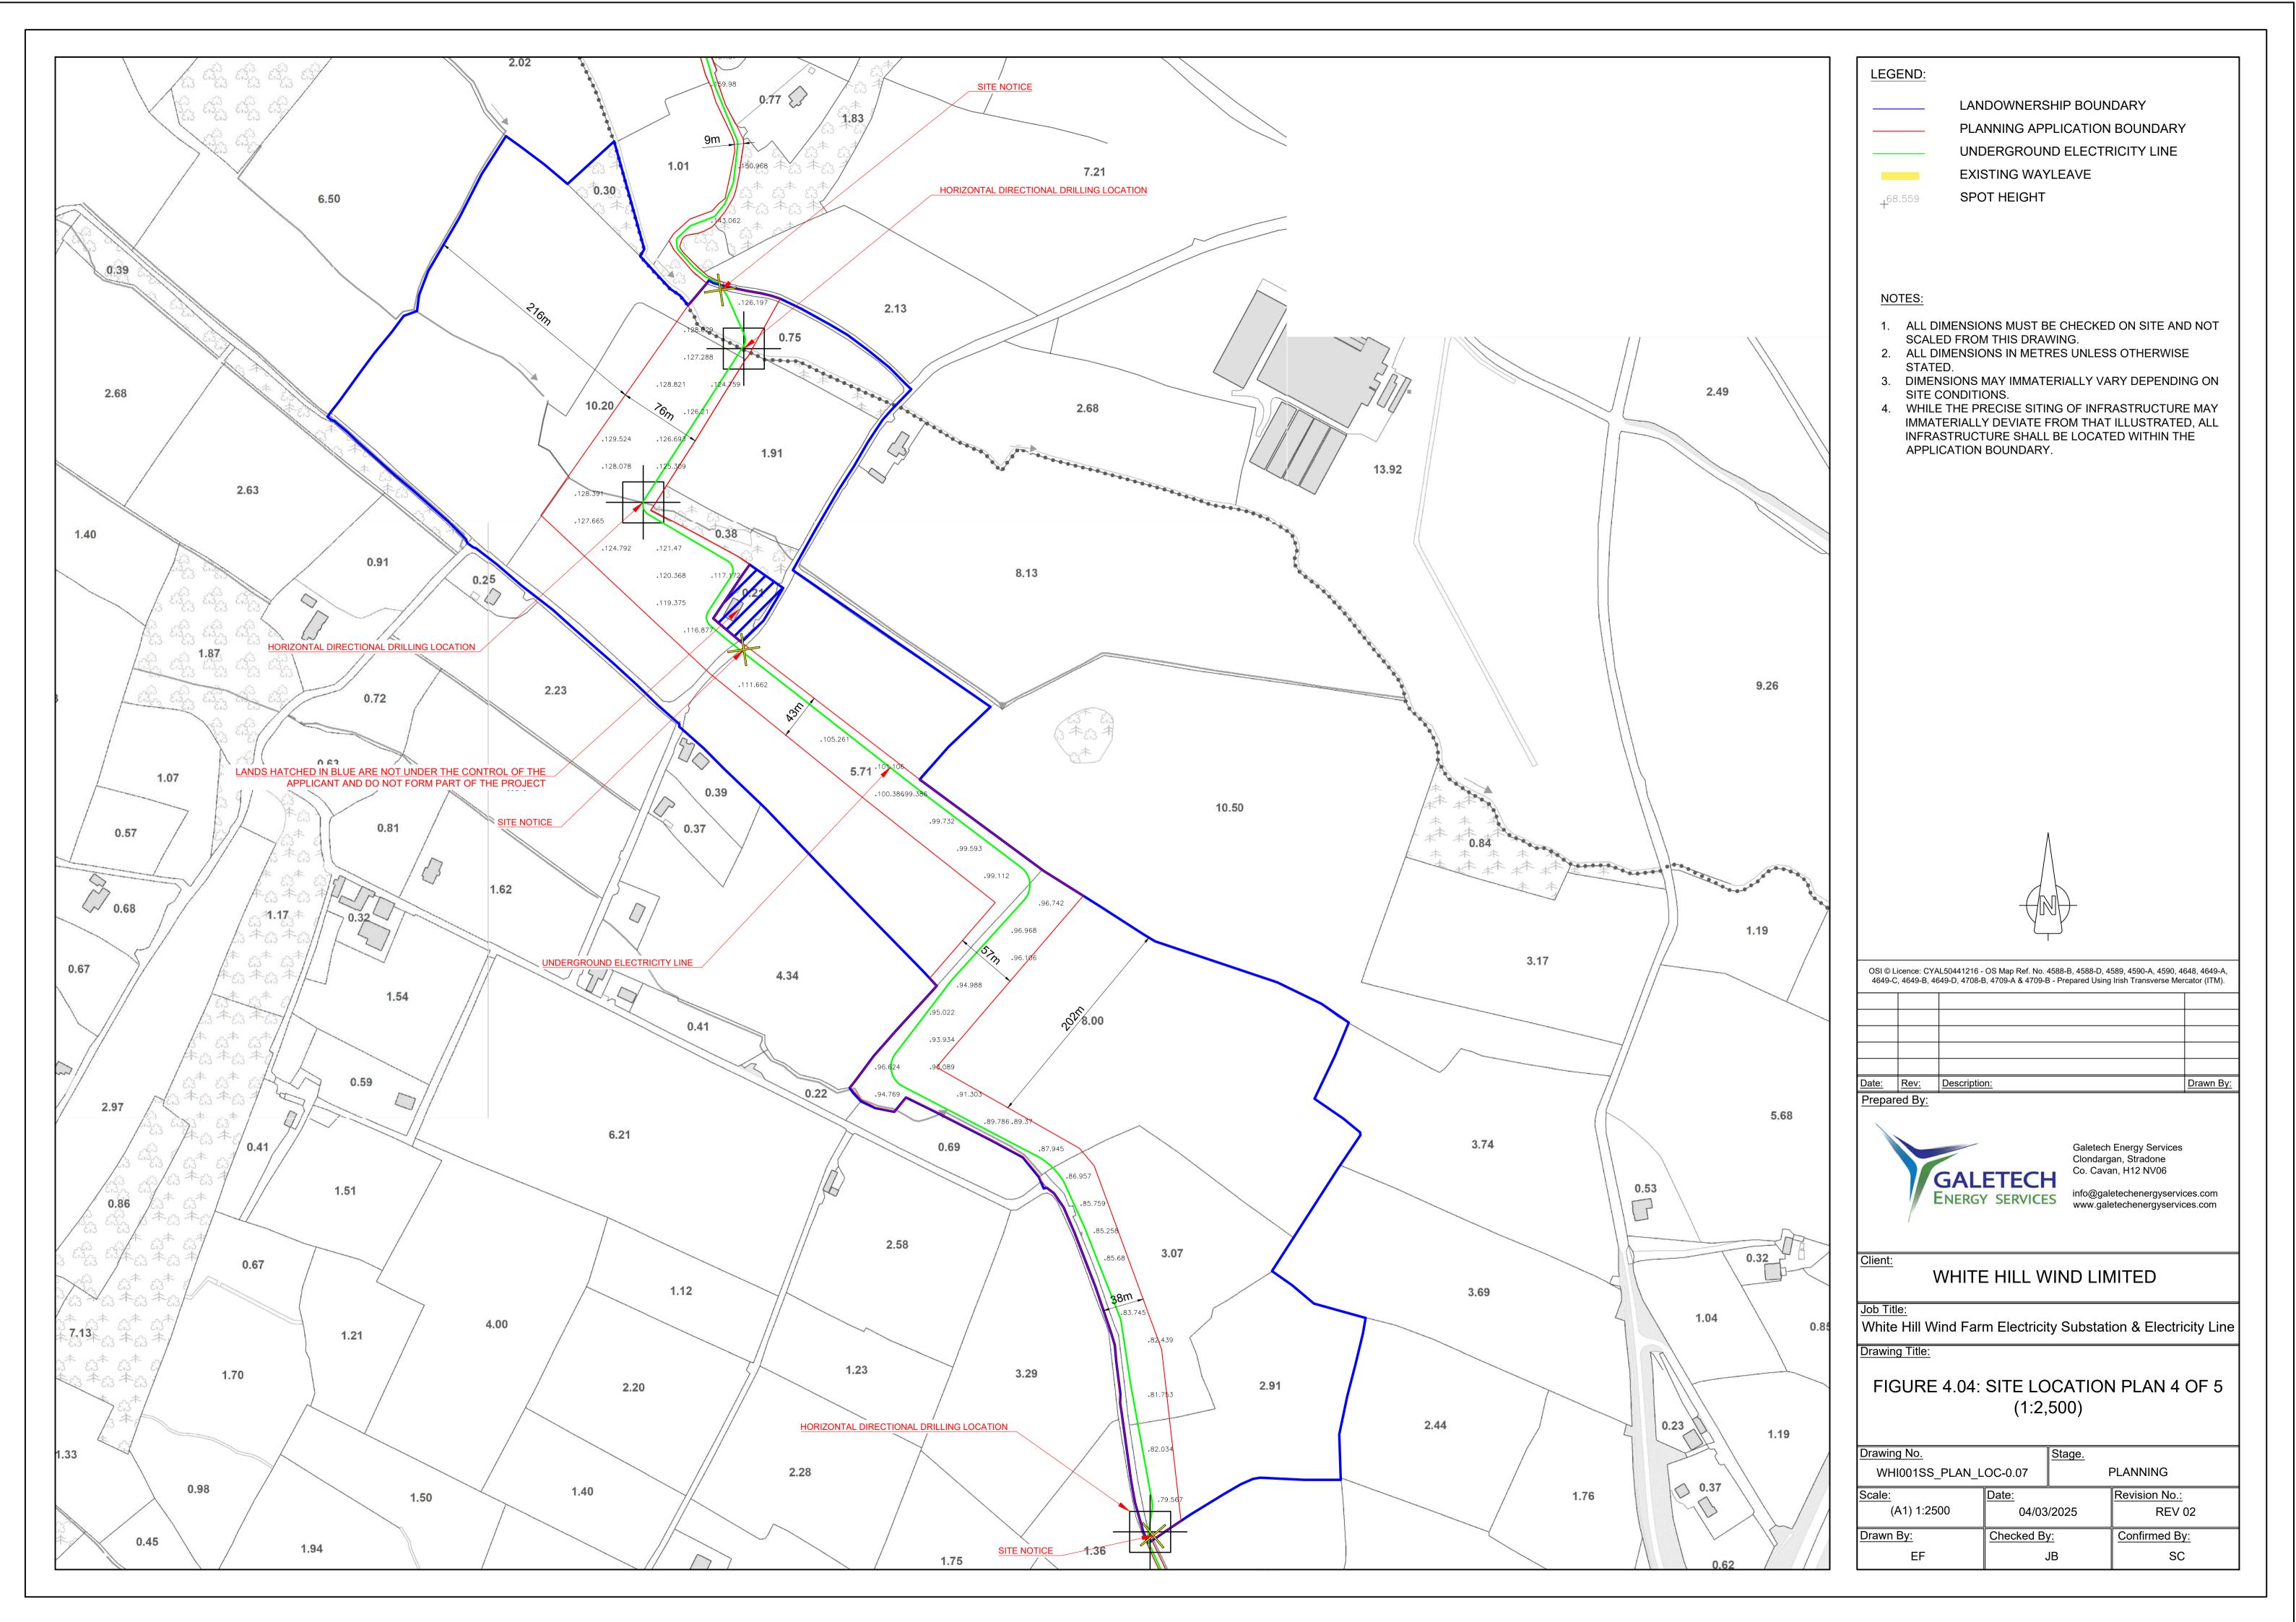

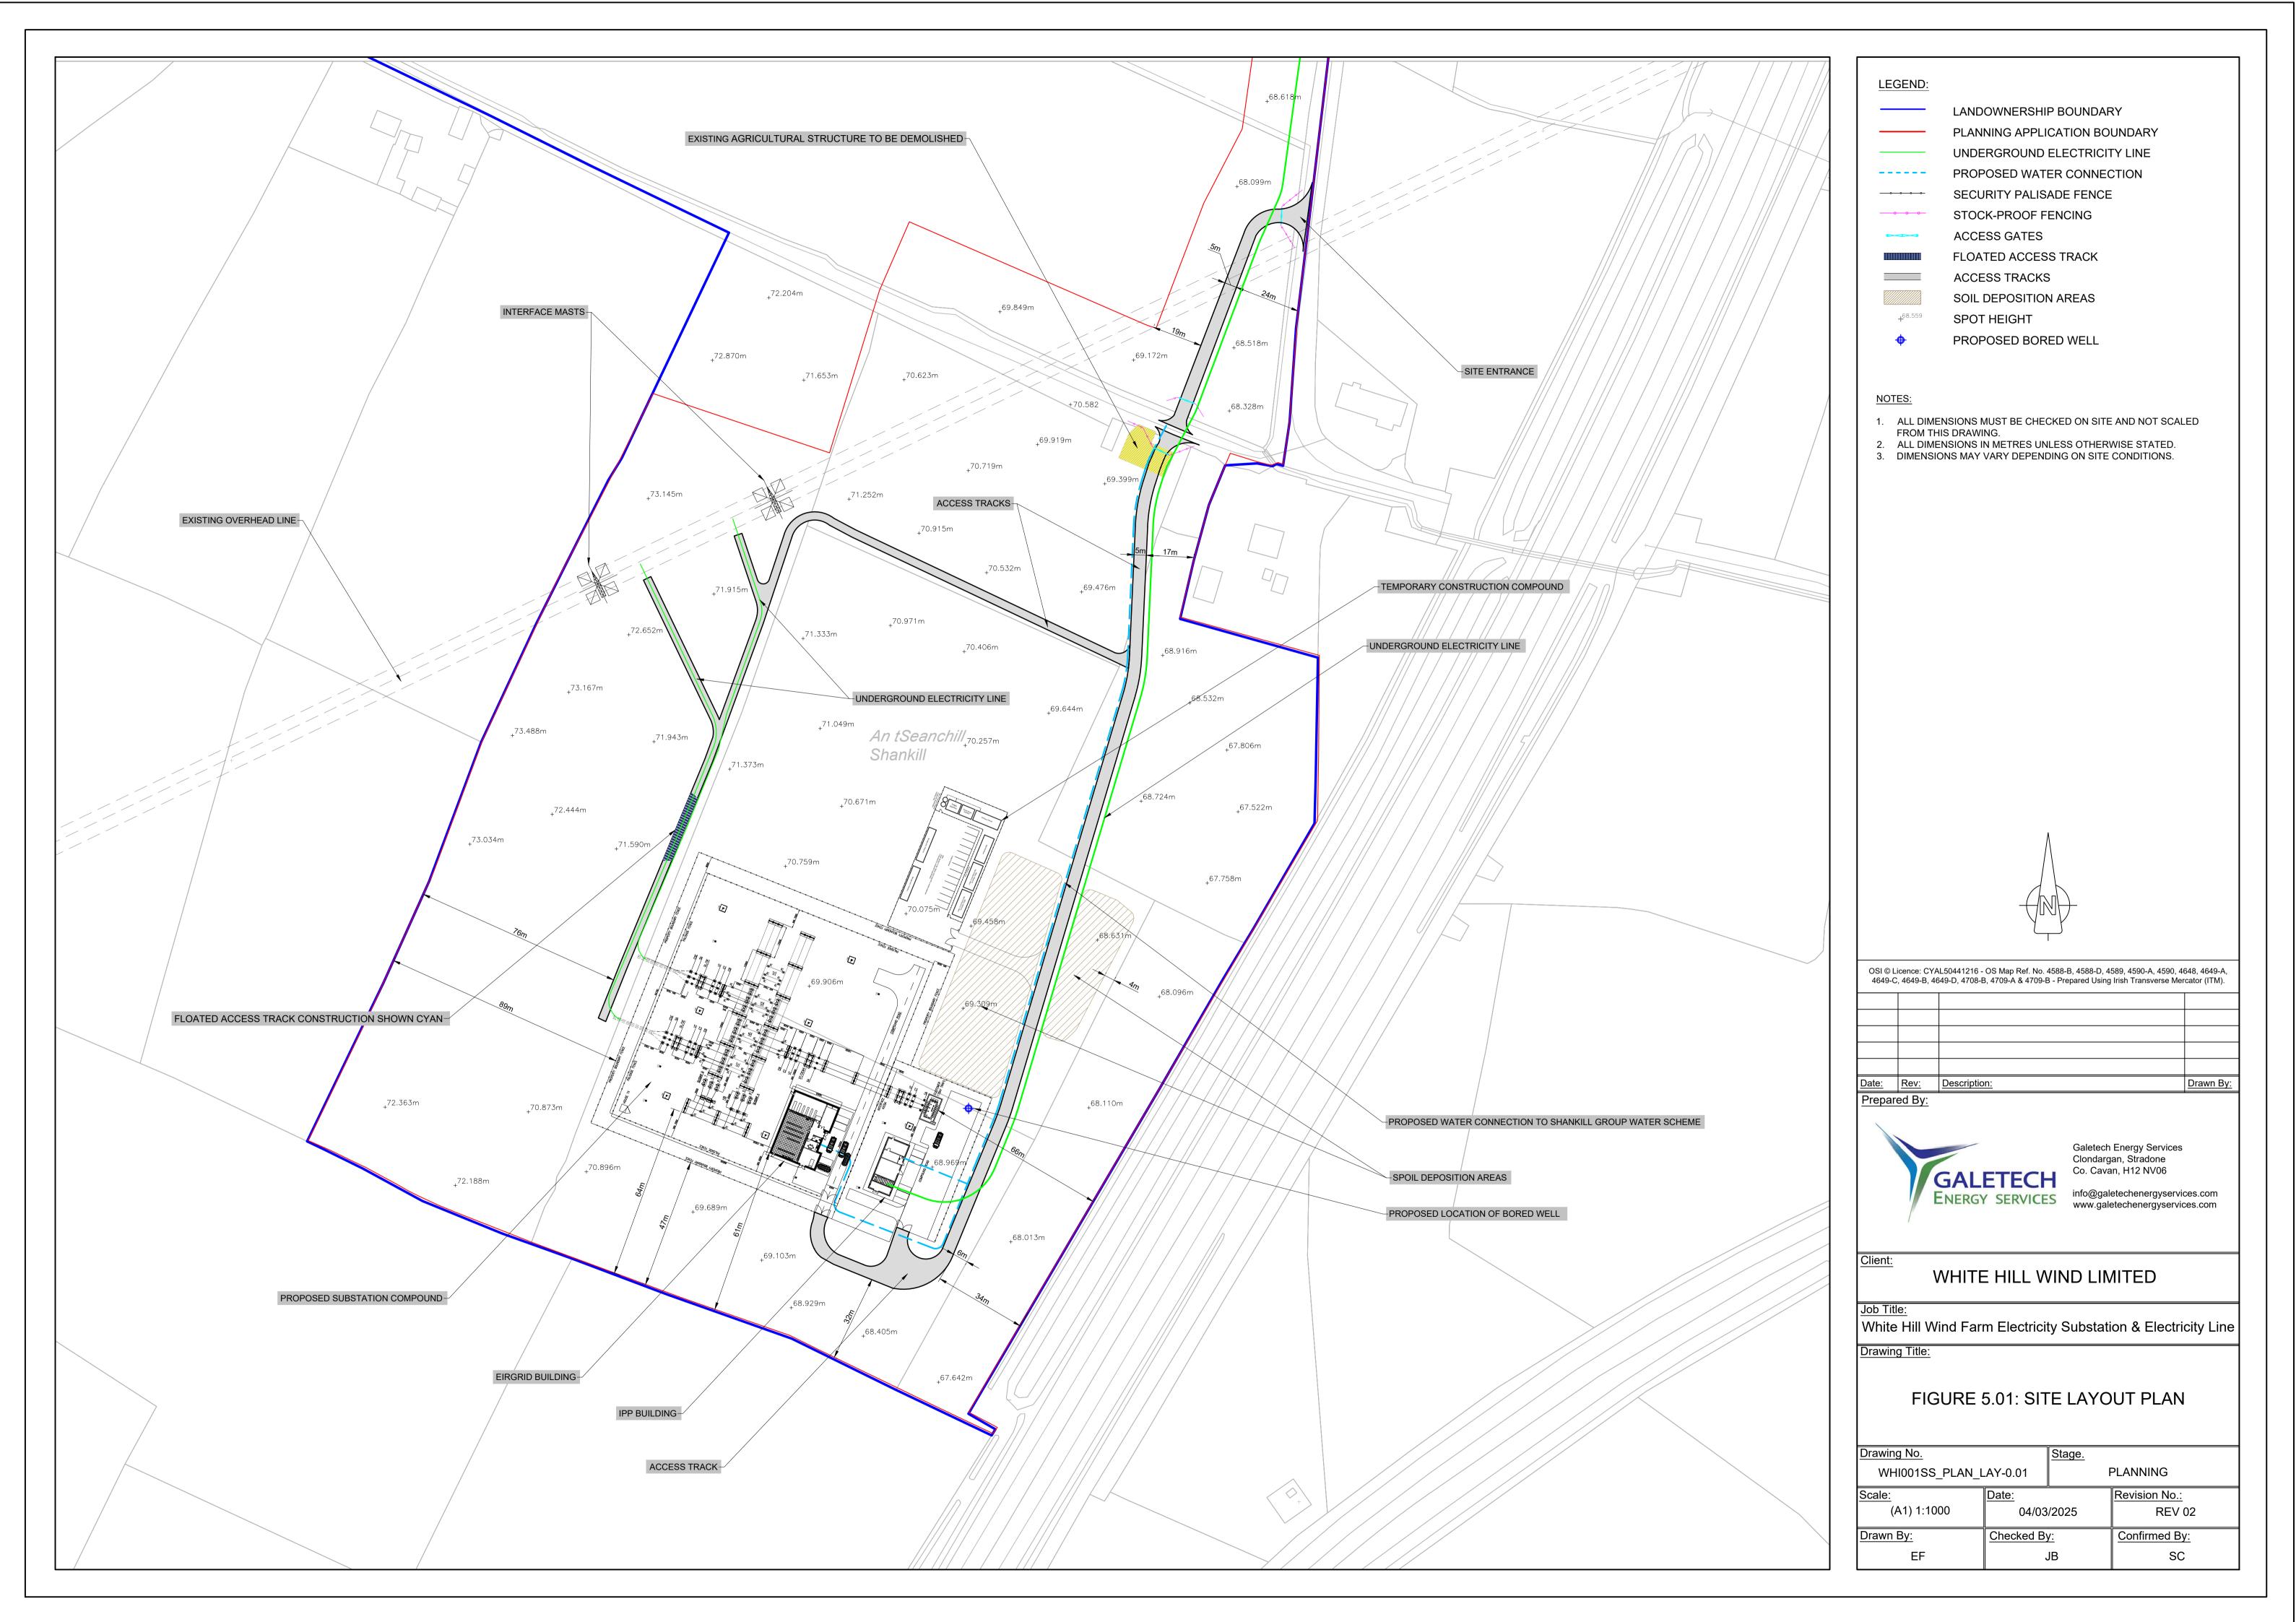


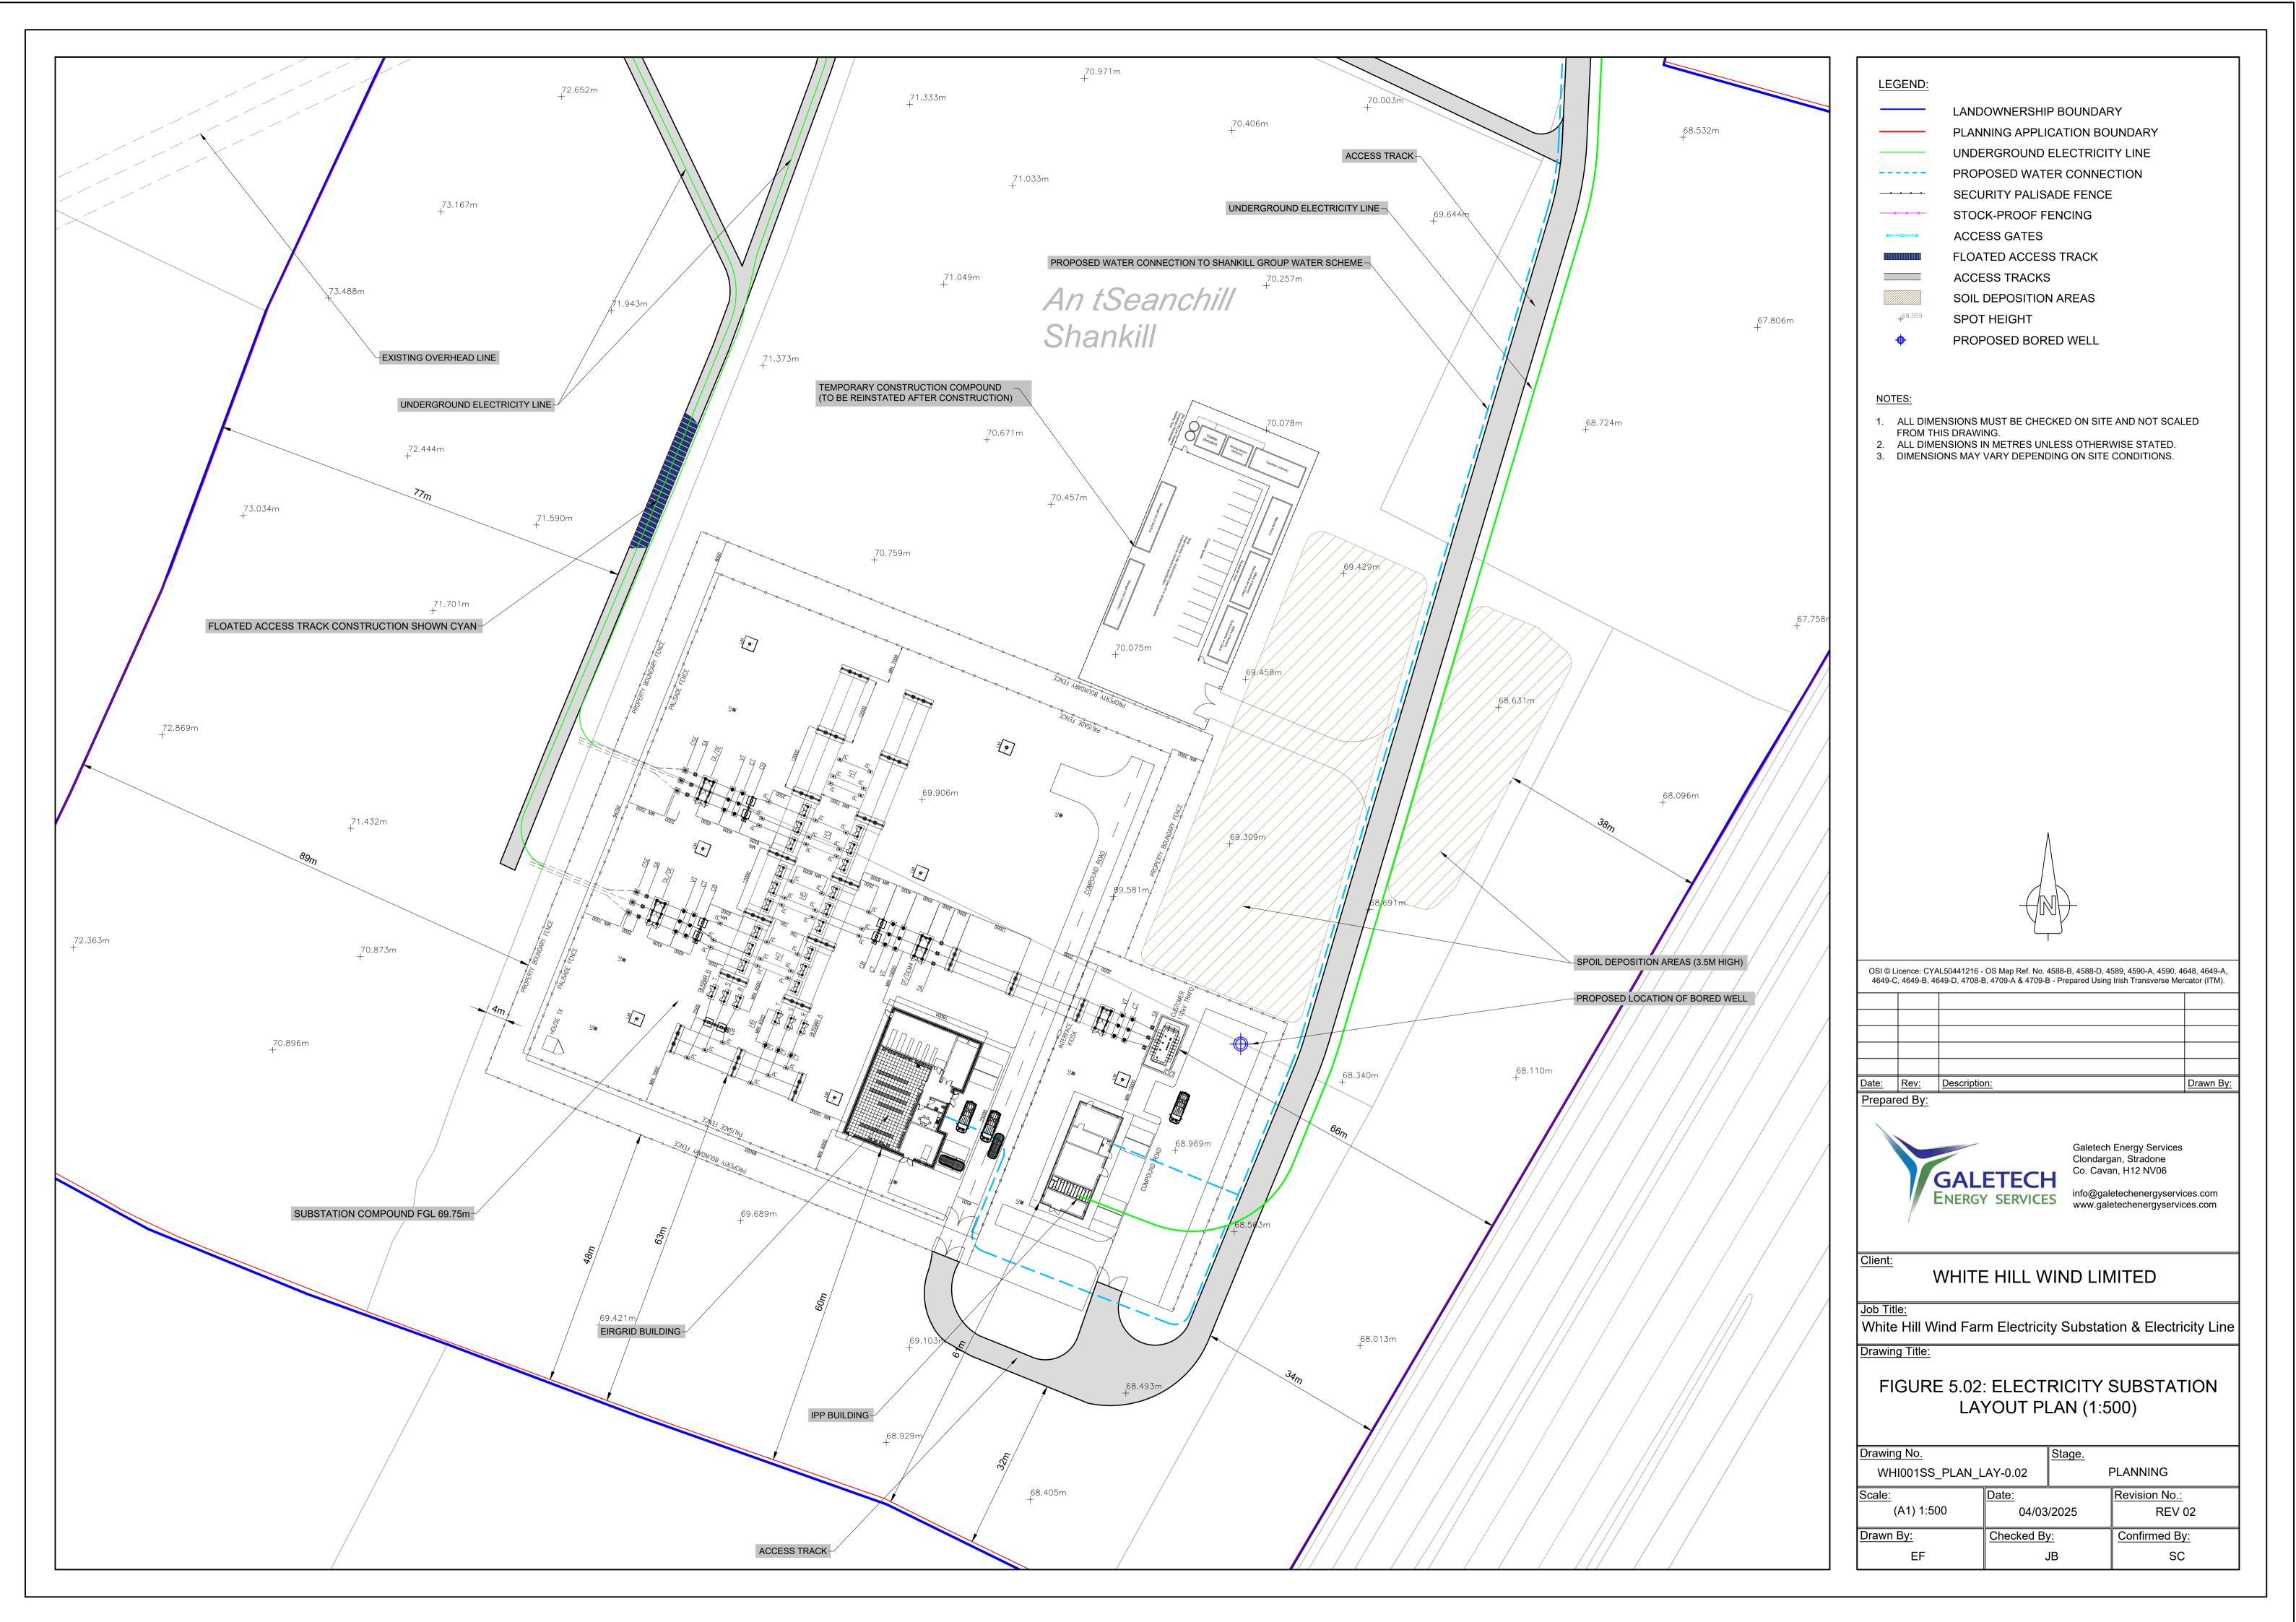

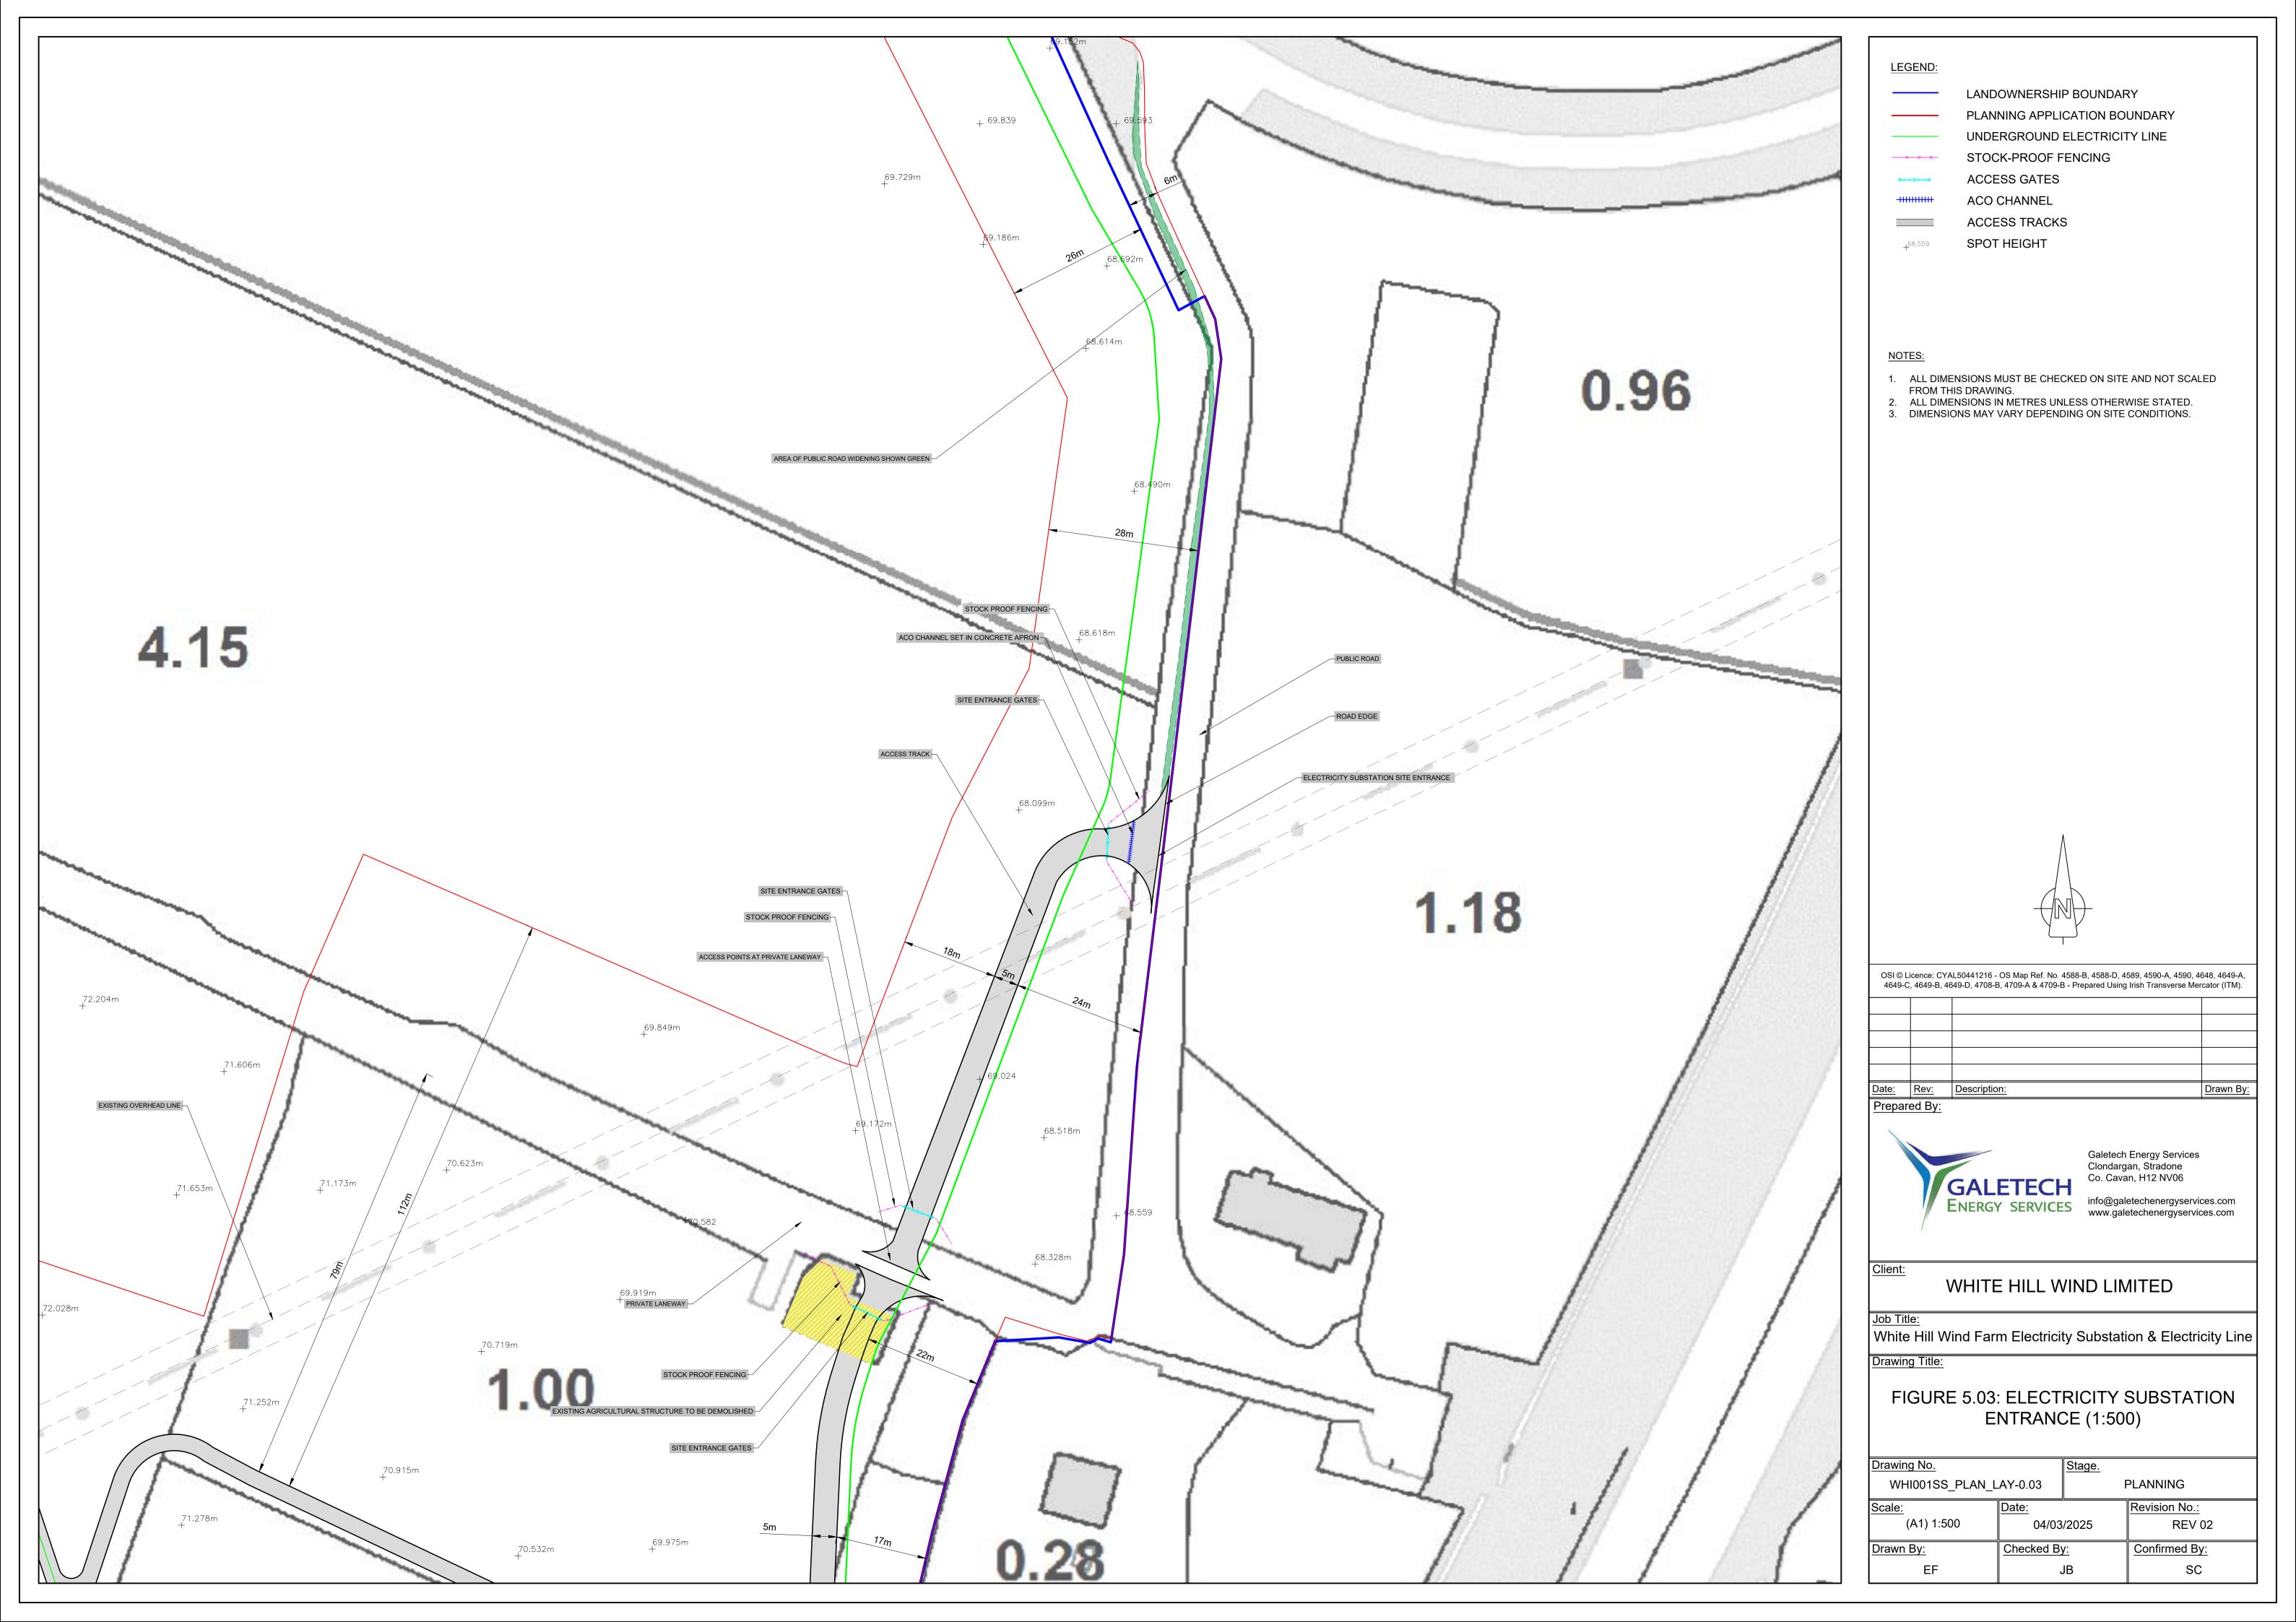


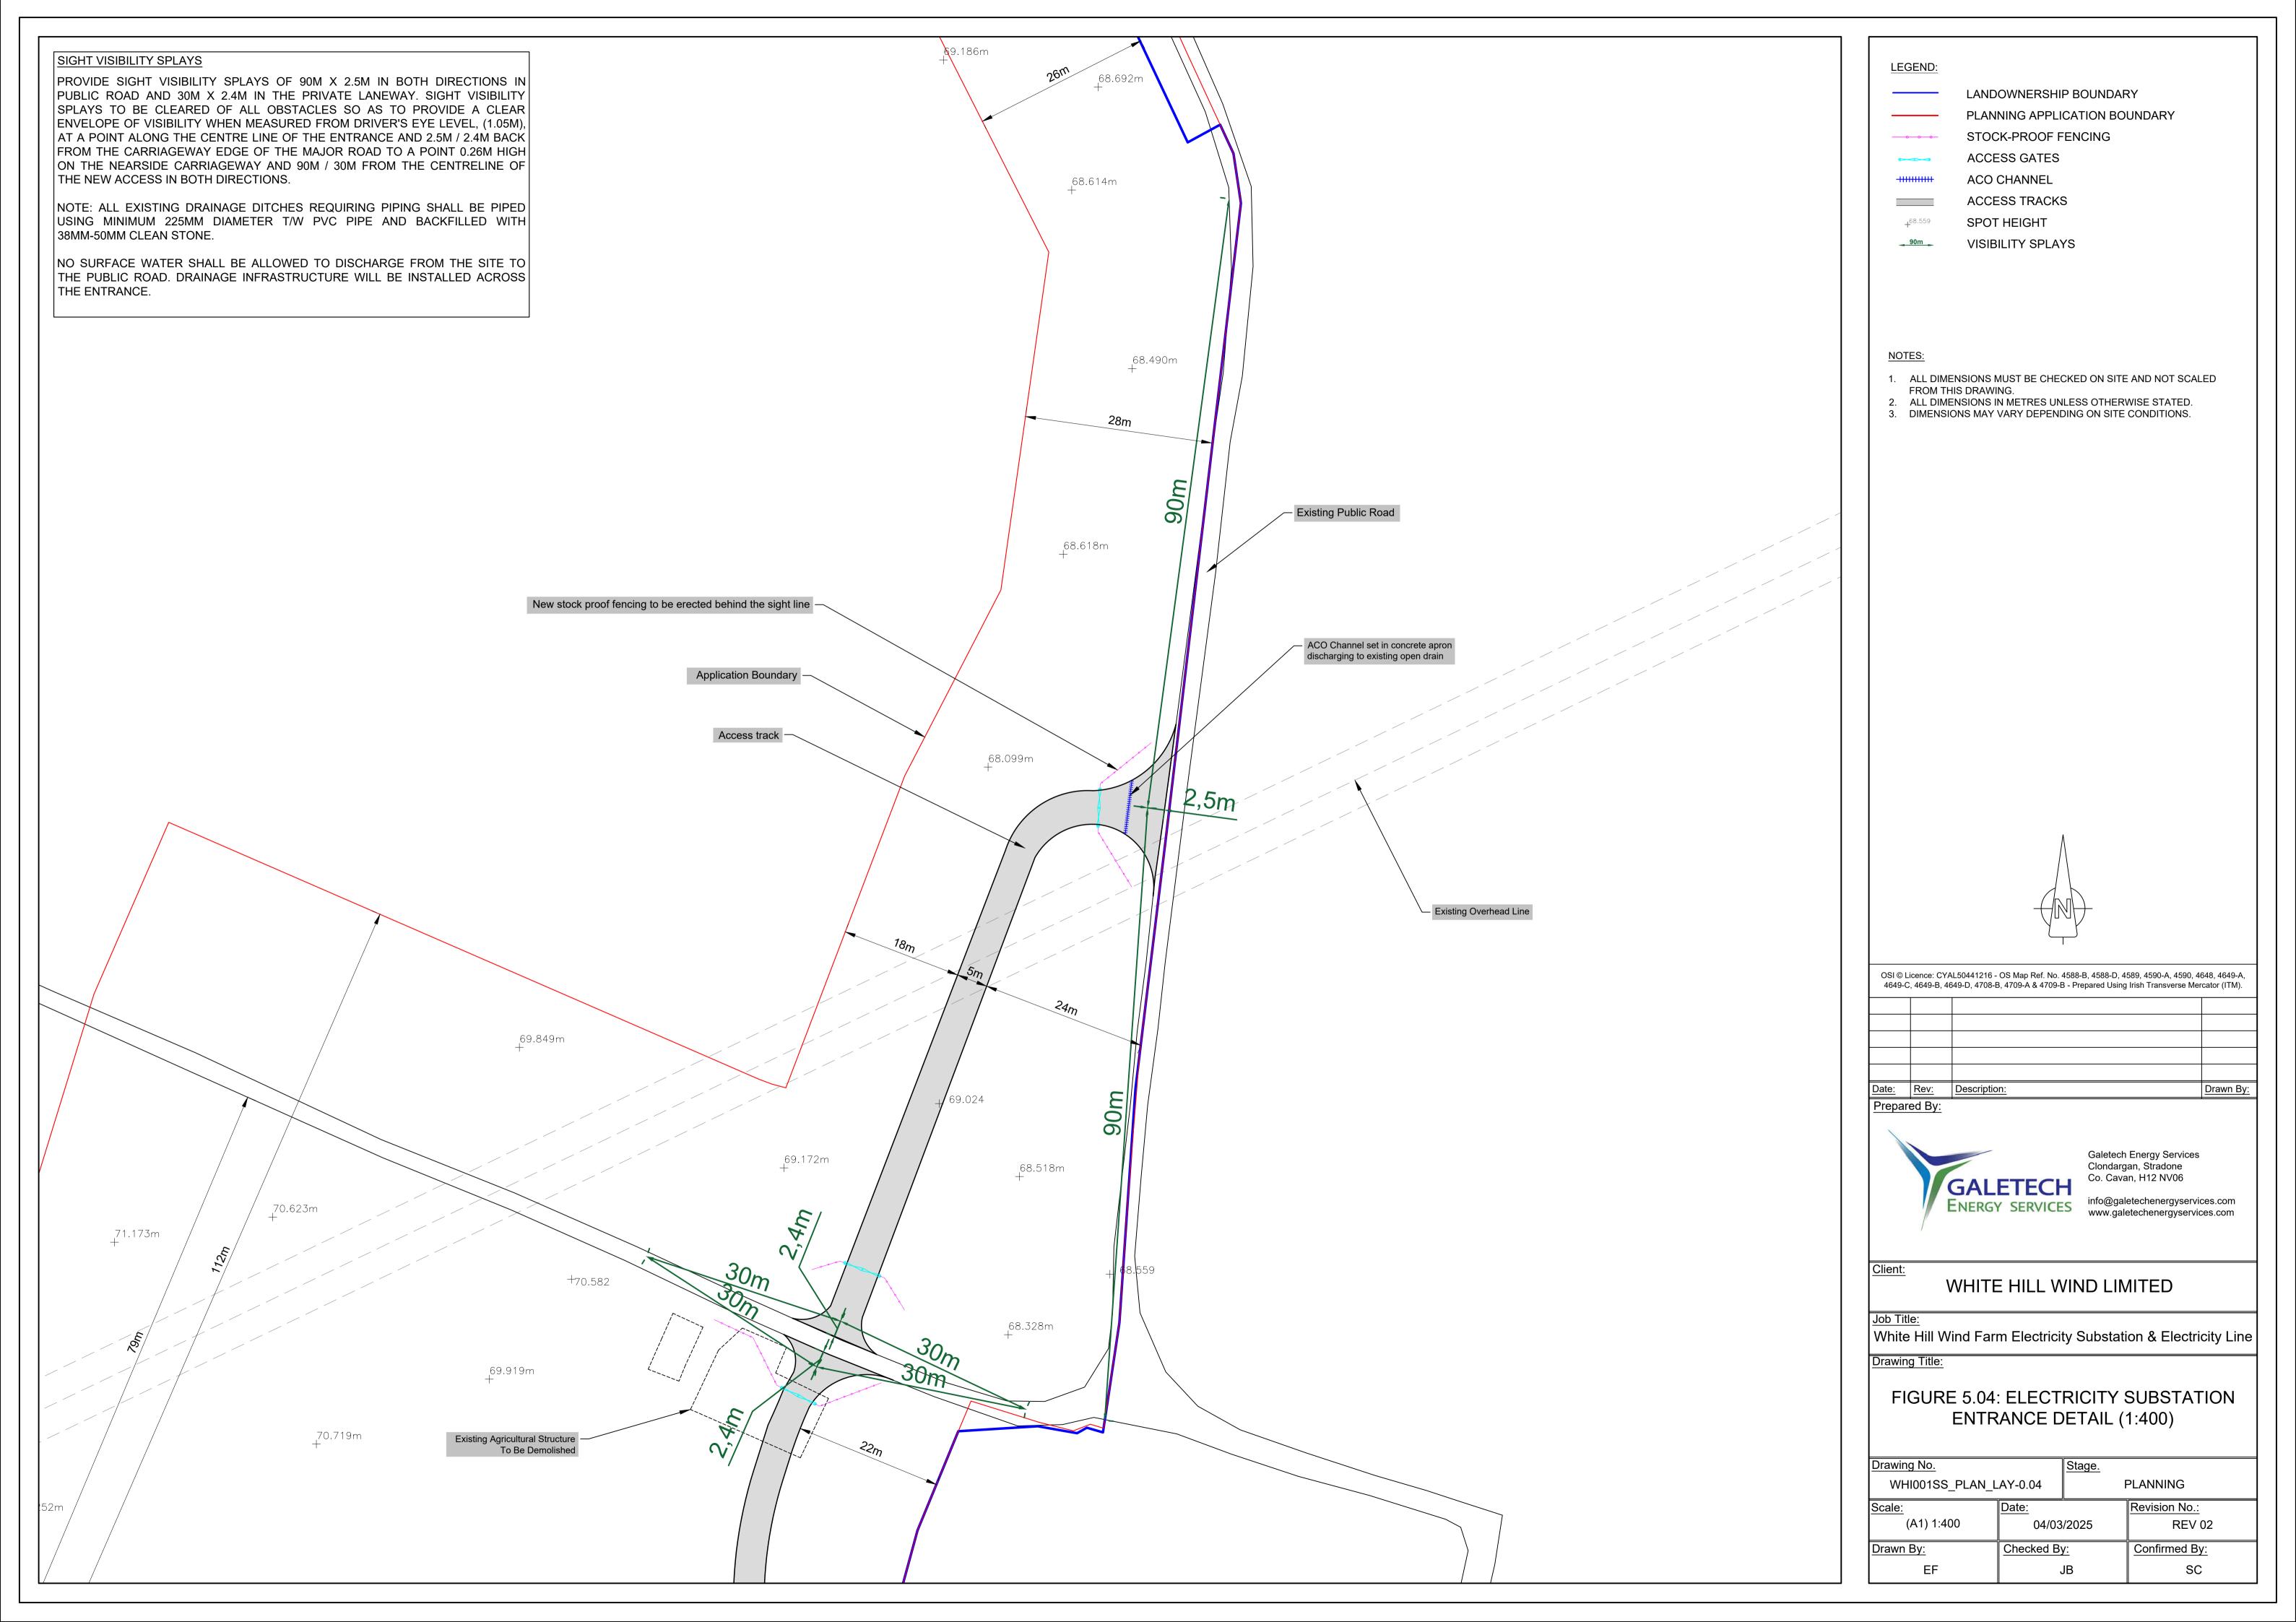


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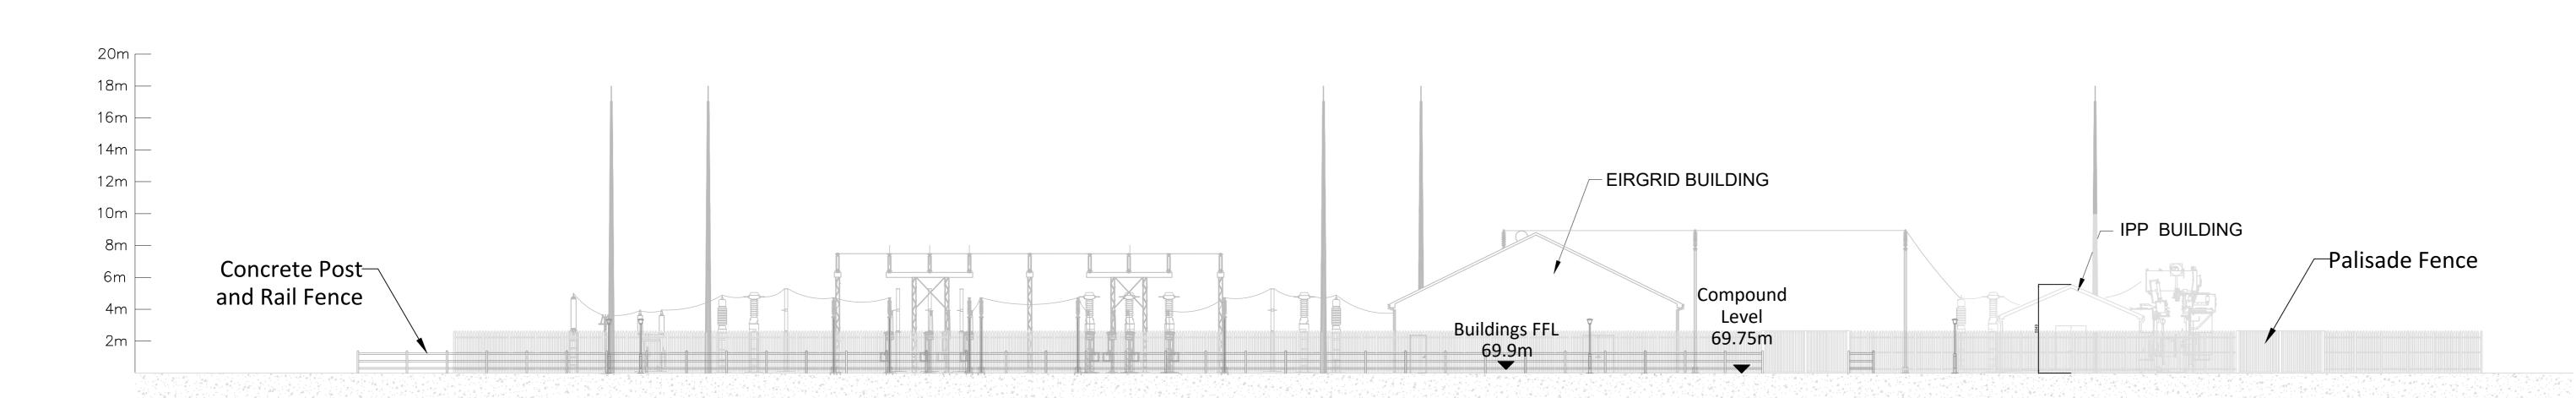
ELEVATION A

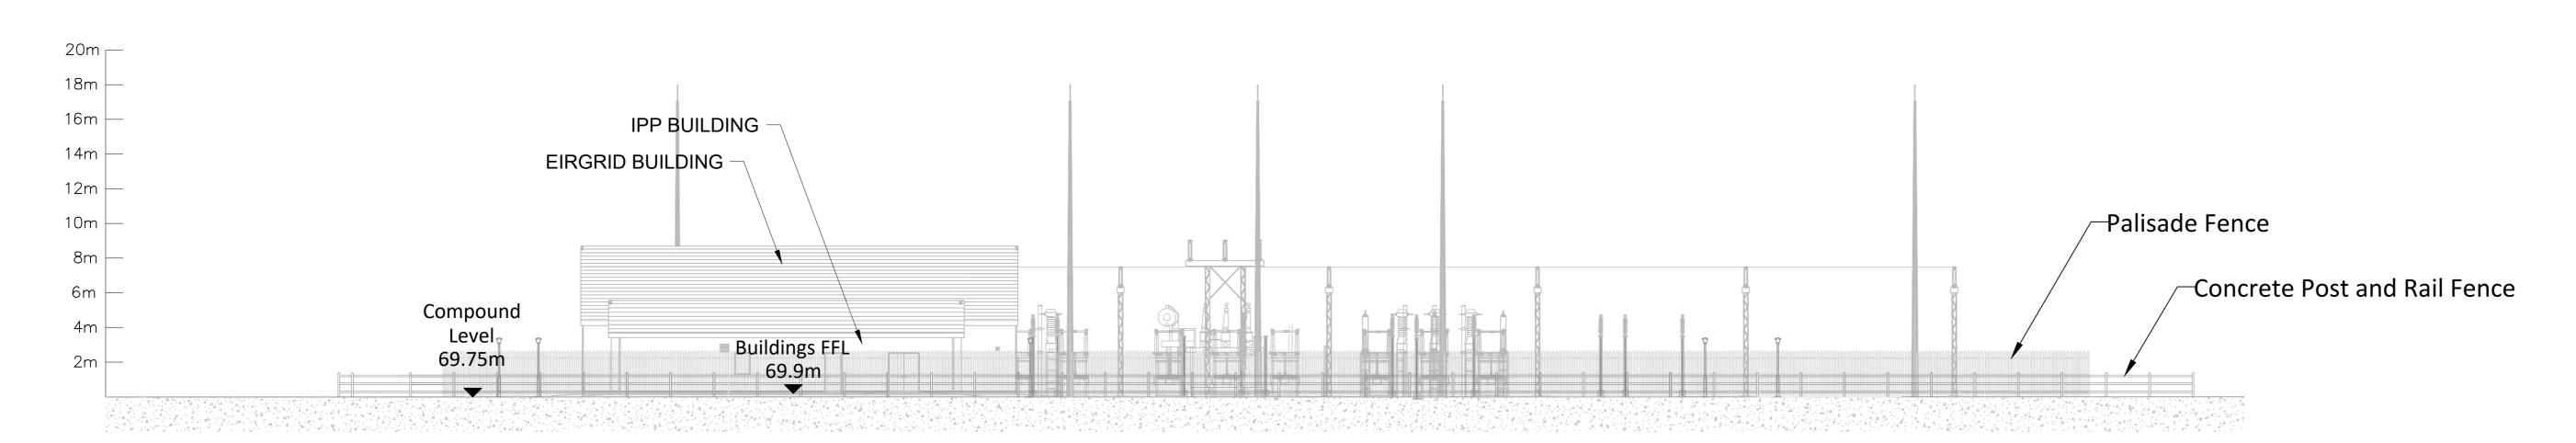

ELEVATION B

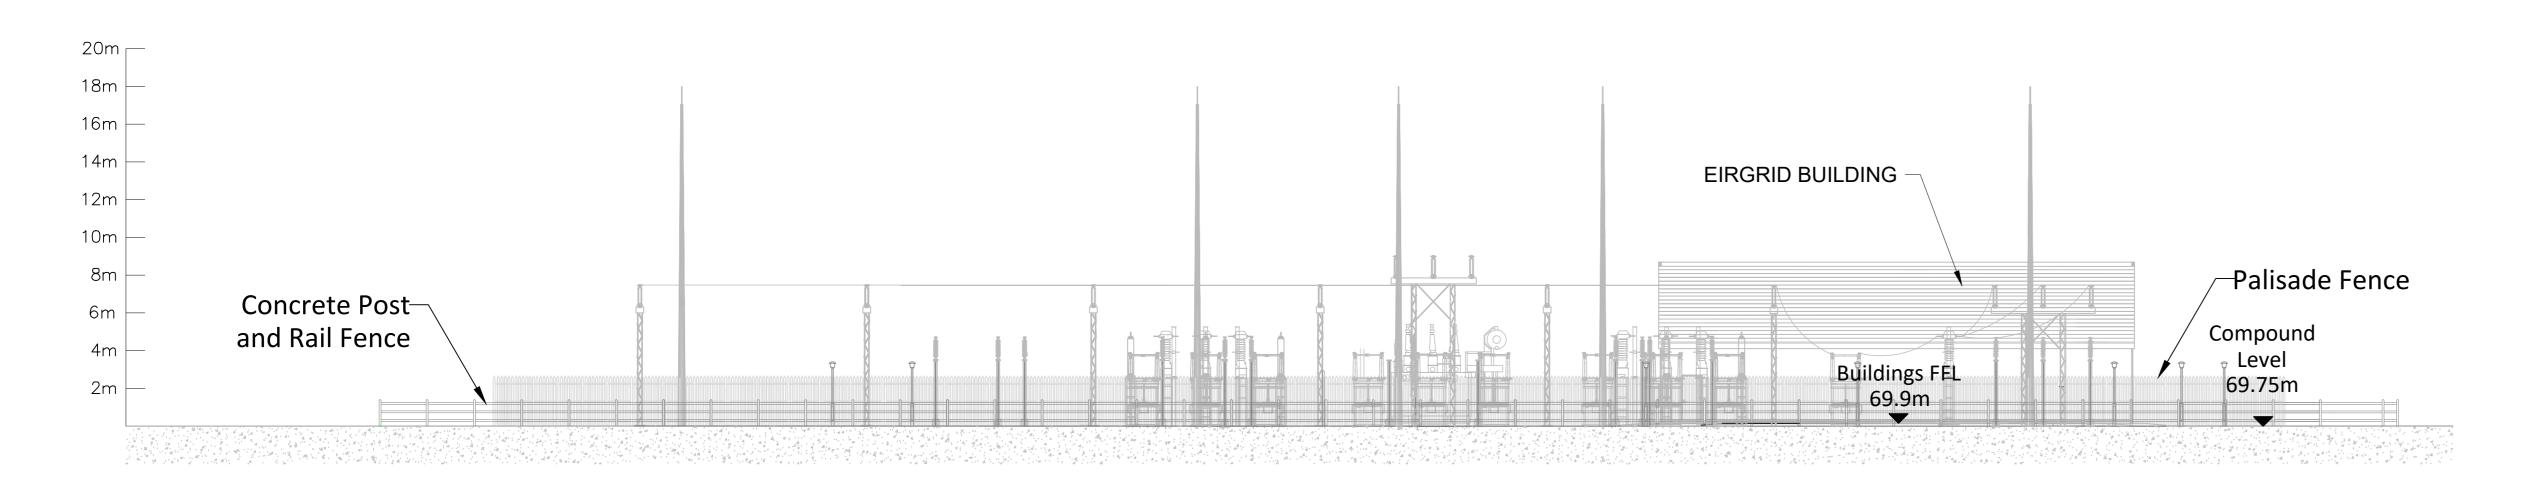



ELEVATION C

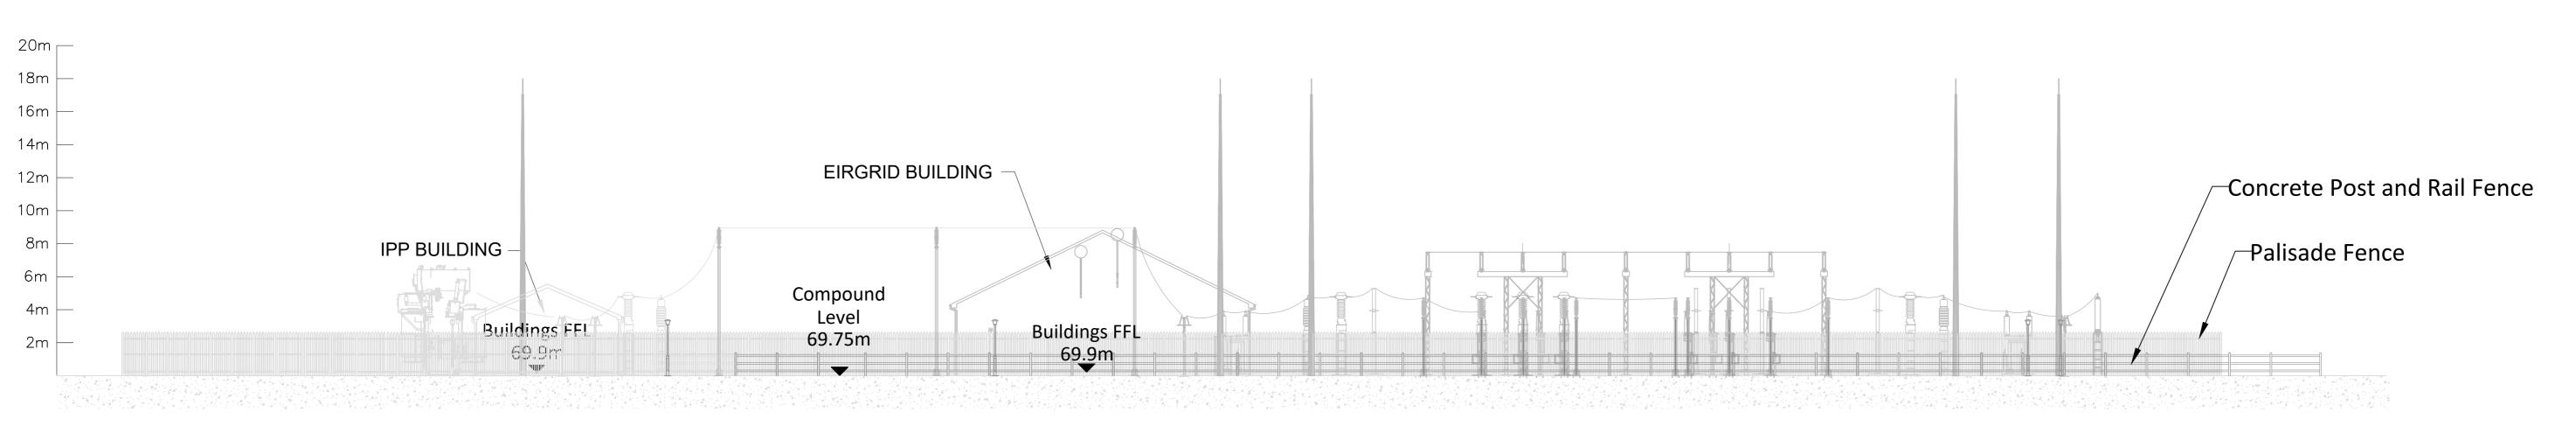

ELEVATION D

- All dimensions must be checked on site and not scaled from this drawing.
- 2. All dimensions in millimetres unless otherwise
- 3. Dimensions may vary depending on site conditions.

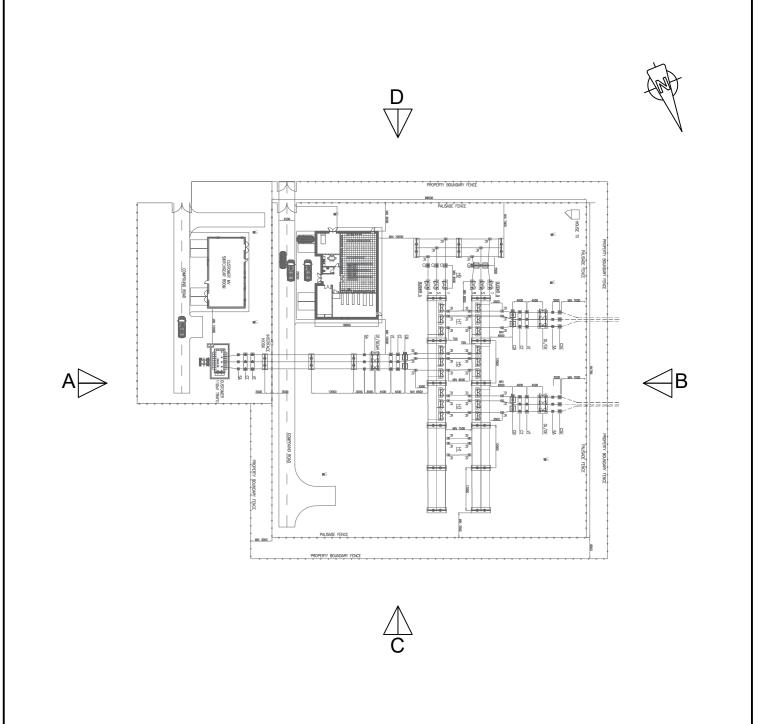

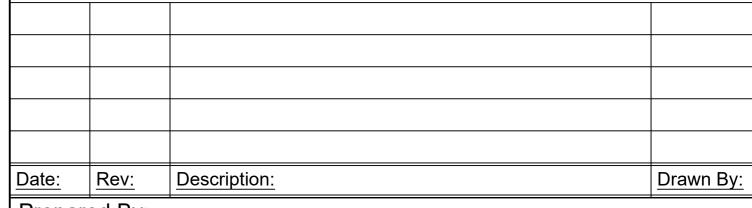

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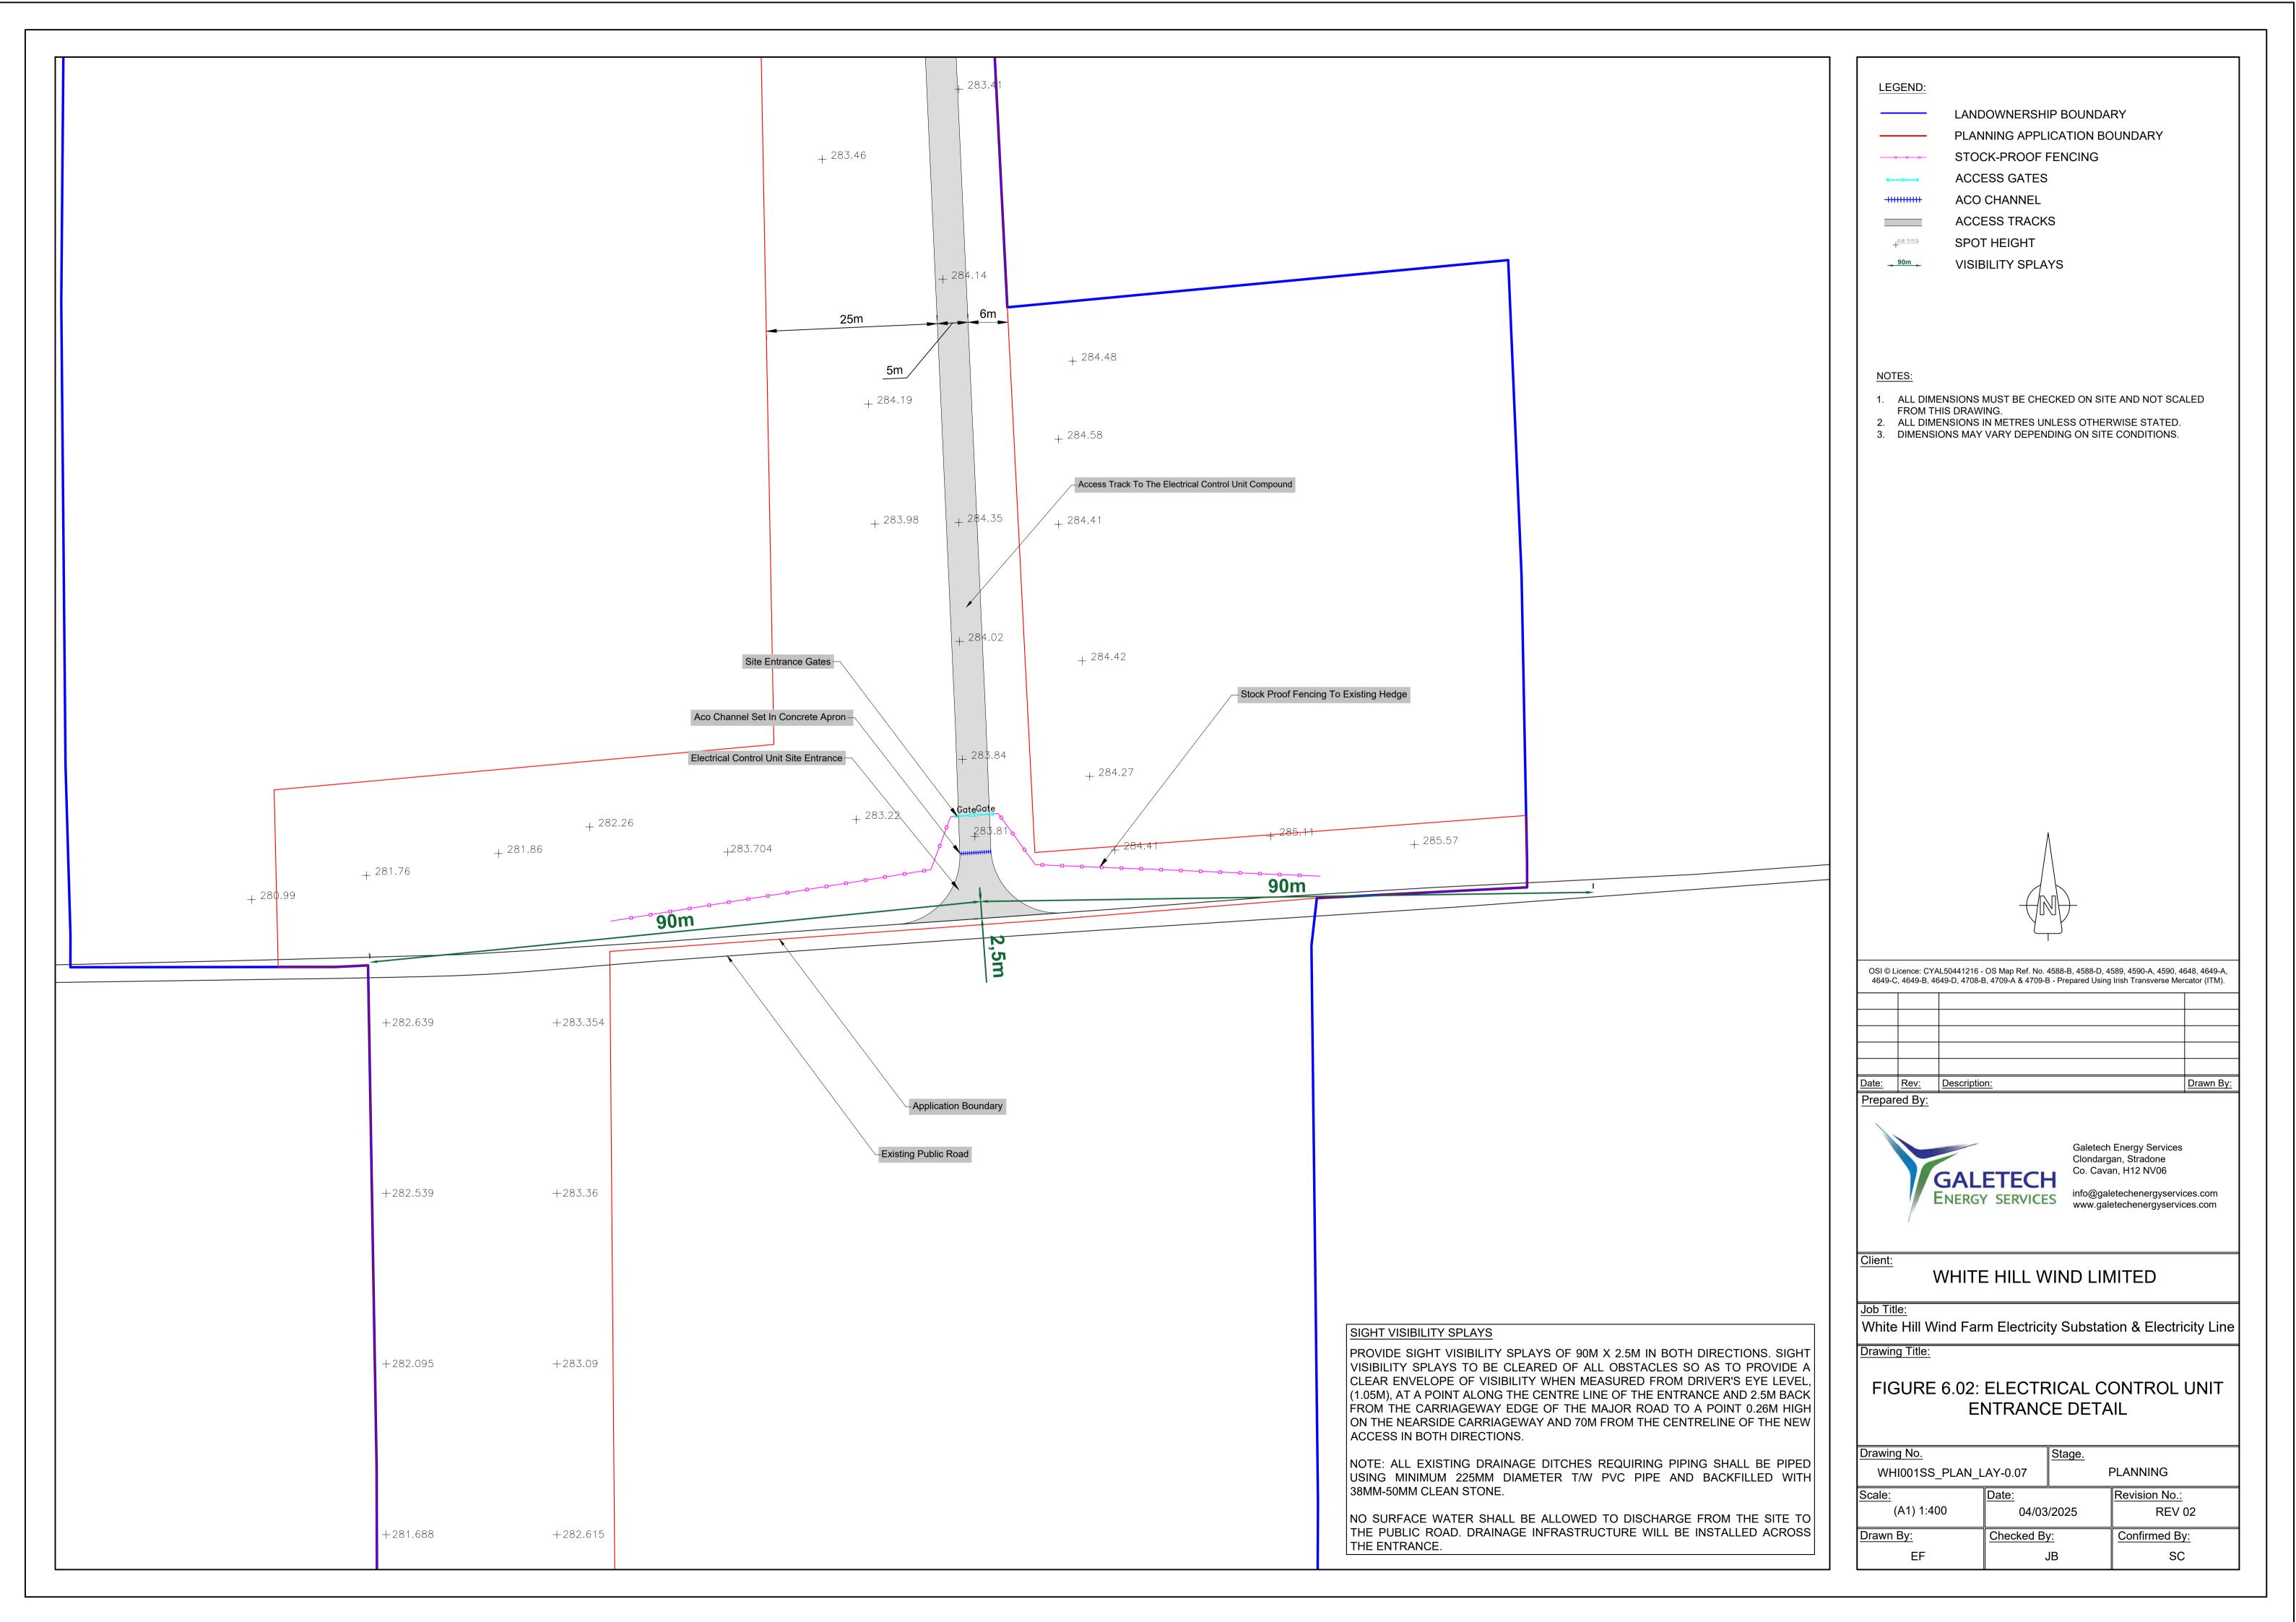
White Hill Wind Farm Electricity Substation & Electricity Line


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FIGURE 5.05: TYPICAL SUBSTATION COMPOUND ELEVATIONS (1:500)

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08/01	/2025	REV 00
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JB		SC
	Date: 08/01 Checked B	Date: 08/01/2025 Checked By:





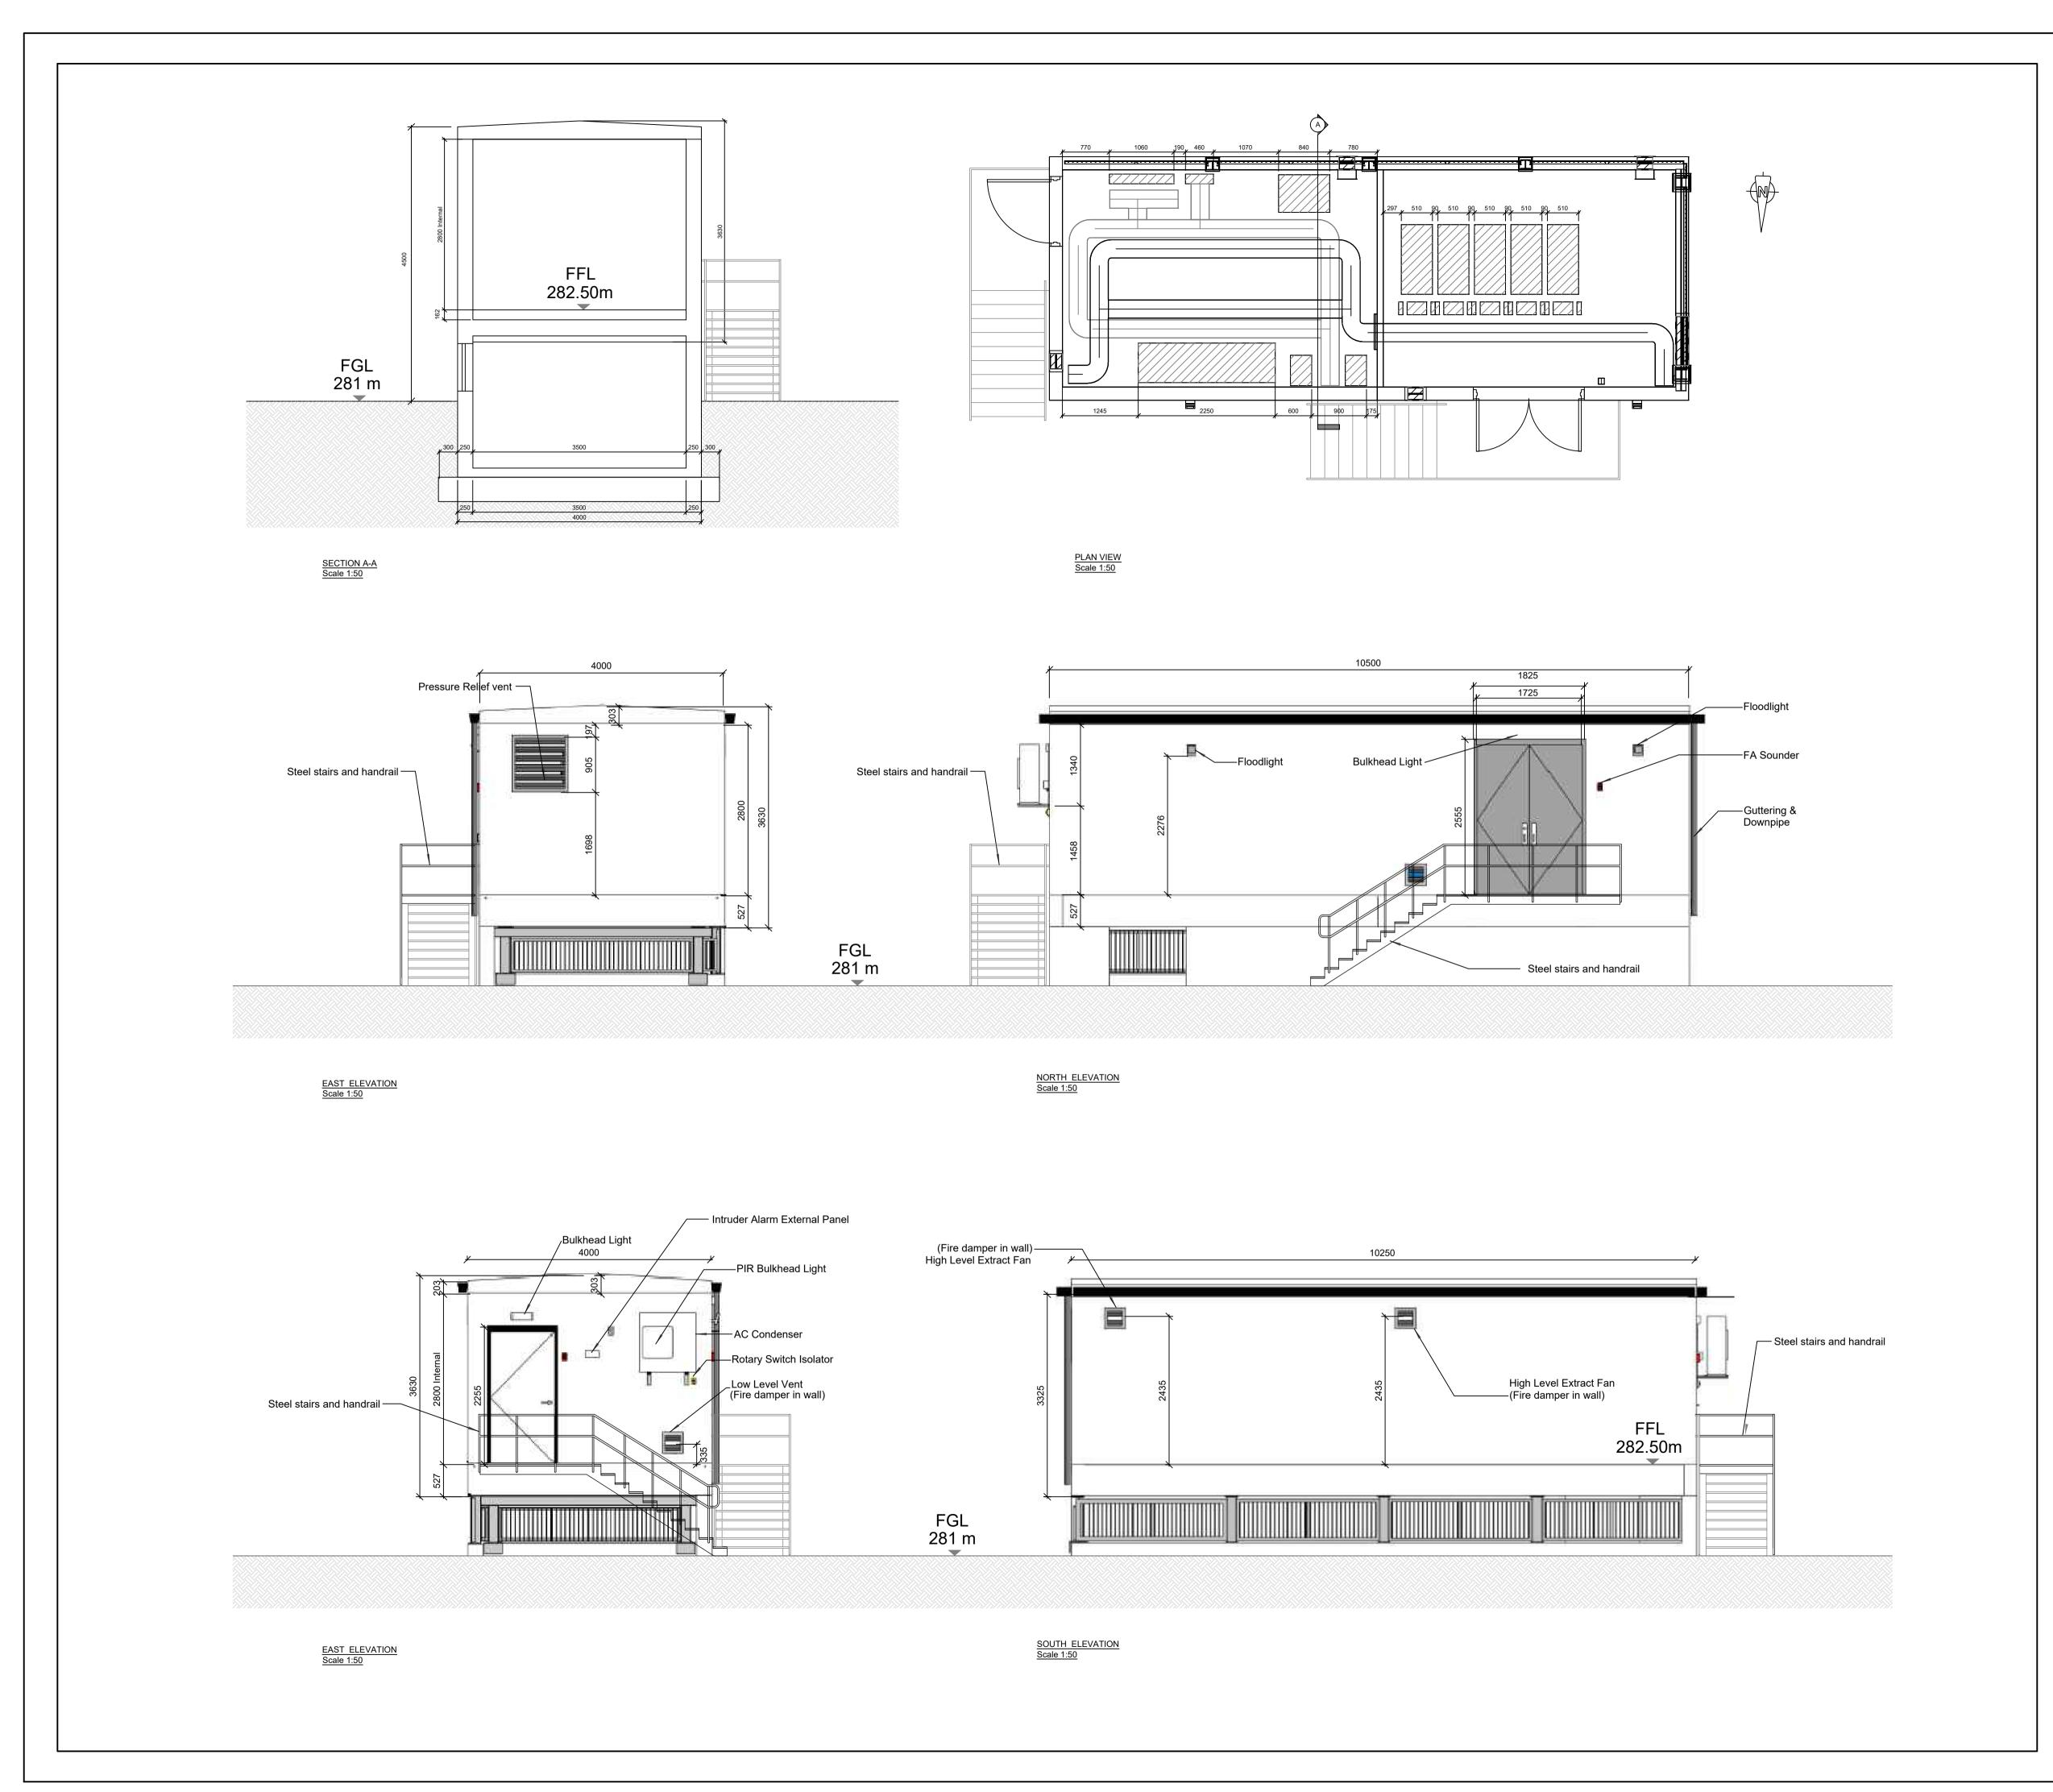

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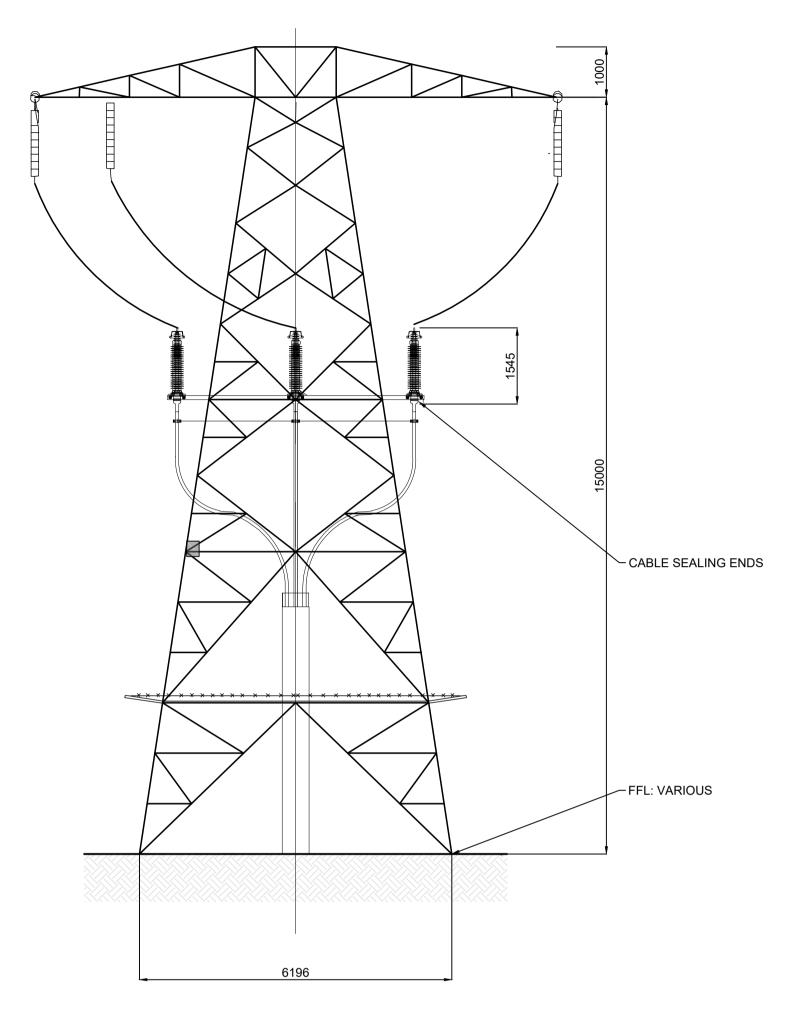
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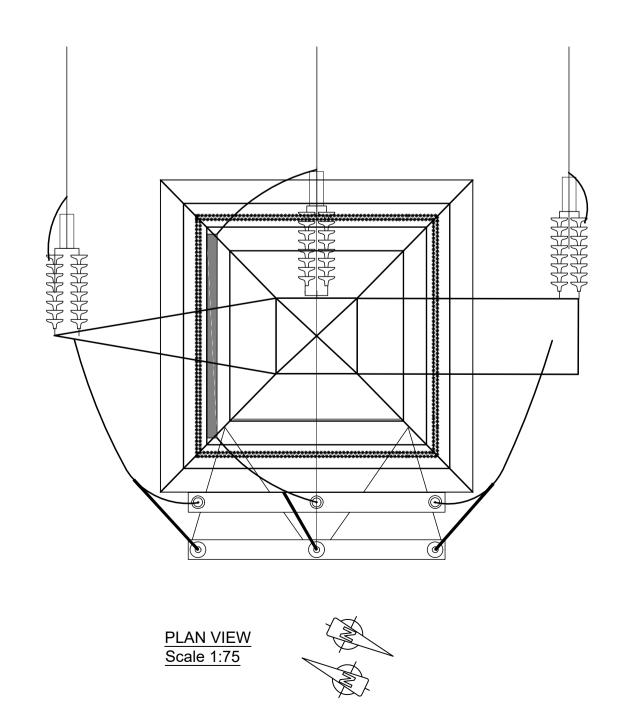
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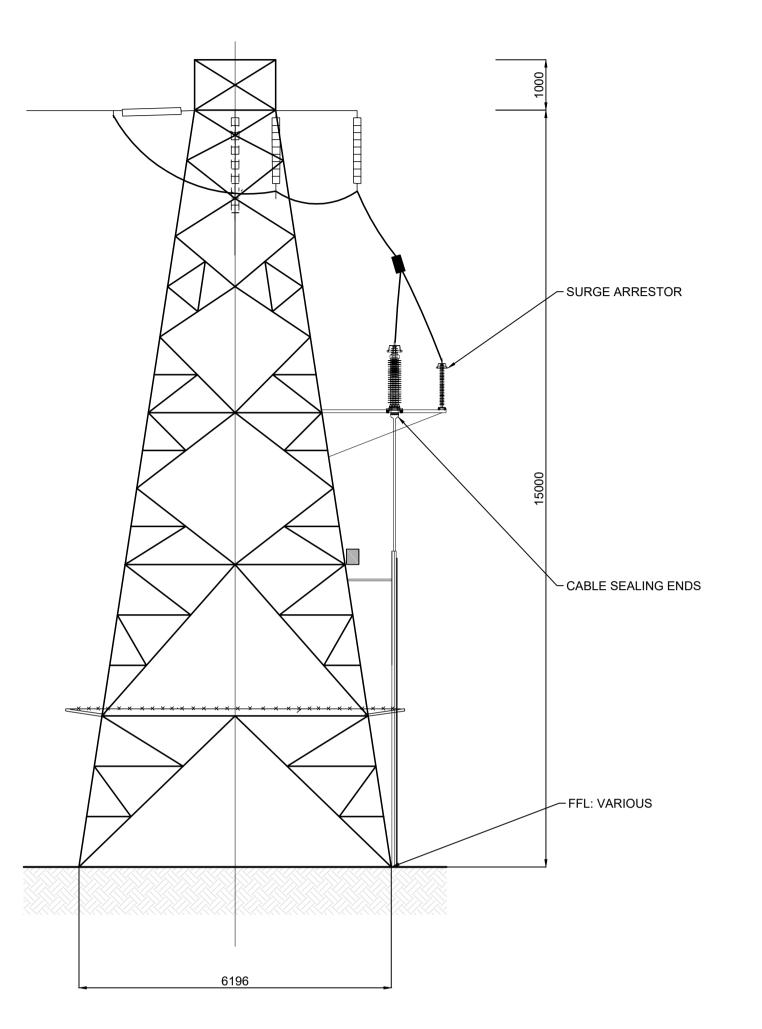
FIGURE 6.03: TYPICAL ELECTRICAL CONTROL UNIT PLAN / ELEVATIONS / SECTIONS

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(A1) 1:50	08/01	/2025	REV 00
Drawn By:	Checked By:		Confirmed By:
EF	JB		SC




FRONT ELEVATION
Scale 1:75





SIDE ELEVATION Scale 1:75

- All dimensions must be checked on site and not scaled from this drawing.
- 2. All dimensions in millimetres unless otherwise stated.
- 3. Dimensions may vary depending on site conditions.
- 4. Depending on the precise specifications of the interface masts to be installed, the overall maximum height may range between 15m and 18m.

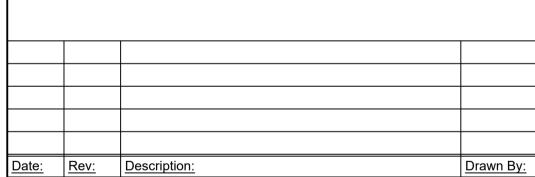

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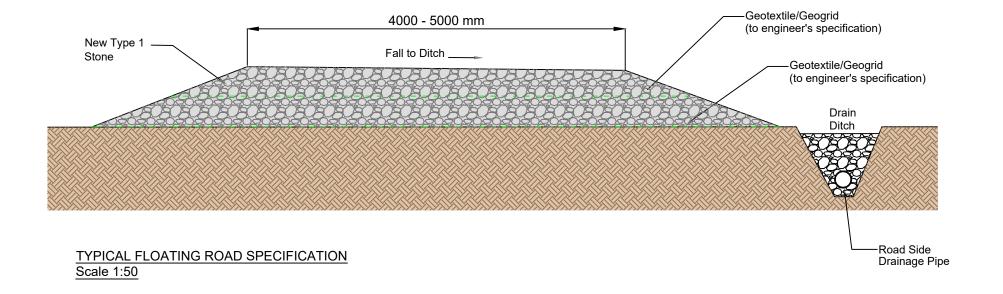
Job Title:

White Hill Wind Farm Electricity Substation & Electricity Line Drawing Title:

FIGURE 7.01: TYPICAL INTERFACE MAST


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Scale:	Date:		Revision No.:
(A1) 1:75	08/01	/2025	REV 00
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EF	J	В	SC

Excavated Material Positioned Each Side of Track 4000 - 5000 mm New Type 1 Stone Fall to Ditch Ditch Ditch Road Side Drainage Pipe GENERAL CROSS SECTION Scale 1:50



Notes:

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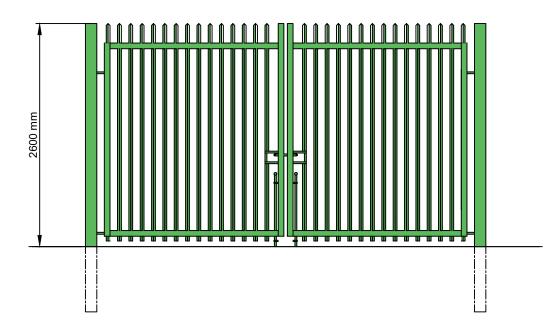
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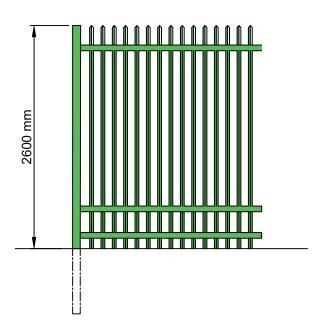
Job Title:
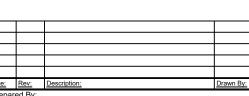
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FIGURE 7.02: TYPICAL ACCESS TRACK DETAIL

<u>Drawing No.</u> WHI001SS_PLAN_0	GA-0.02	Stage.	PLANNING
Scale: (A3) 1:50	<u>Date:</u> 08/01/2025		Revision No.: REV 00
<u>Drawn By:</u> EF	Checked By: JB		Confirmed By: SC





SECURITY FENCE GATE DETAIL Scale 1:50

Notes:

- 1. All dimensions must be checked on site and not scaled from this drawing.
- 2. All dimensions in millimetres unless otherwise stated.
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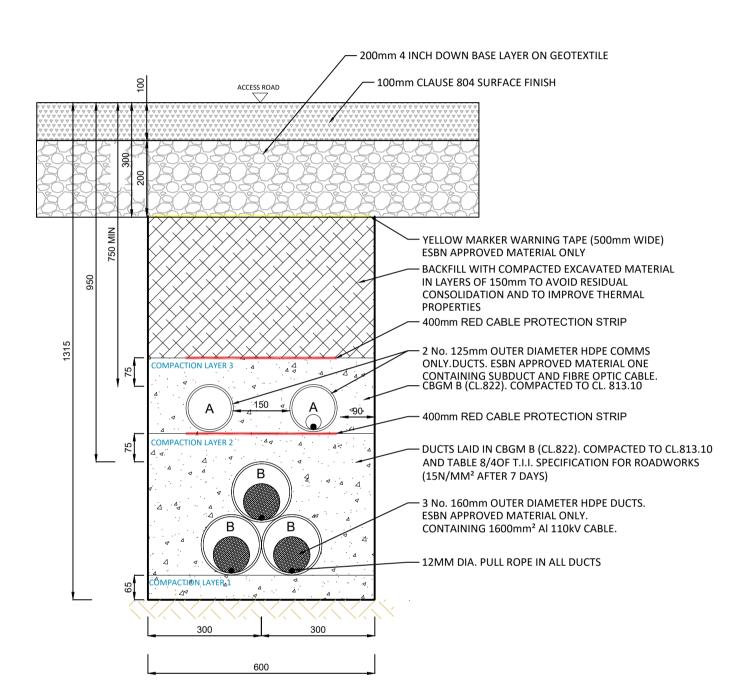
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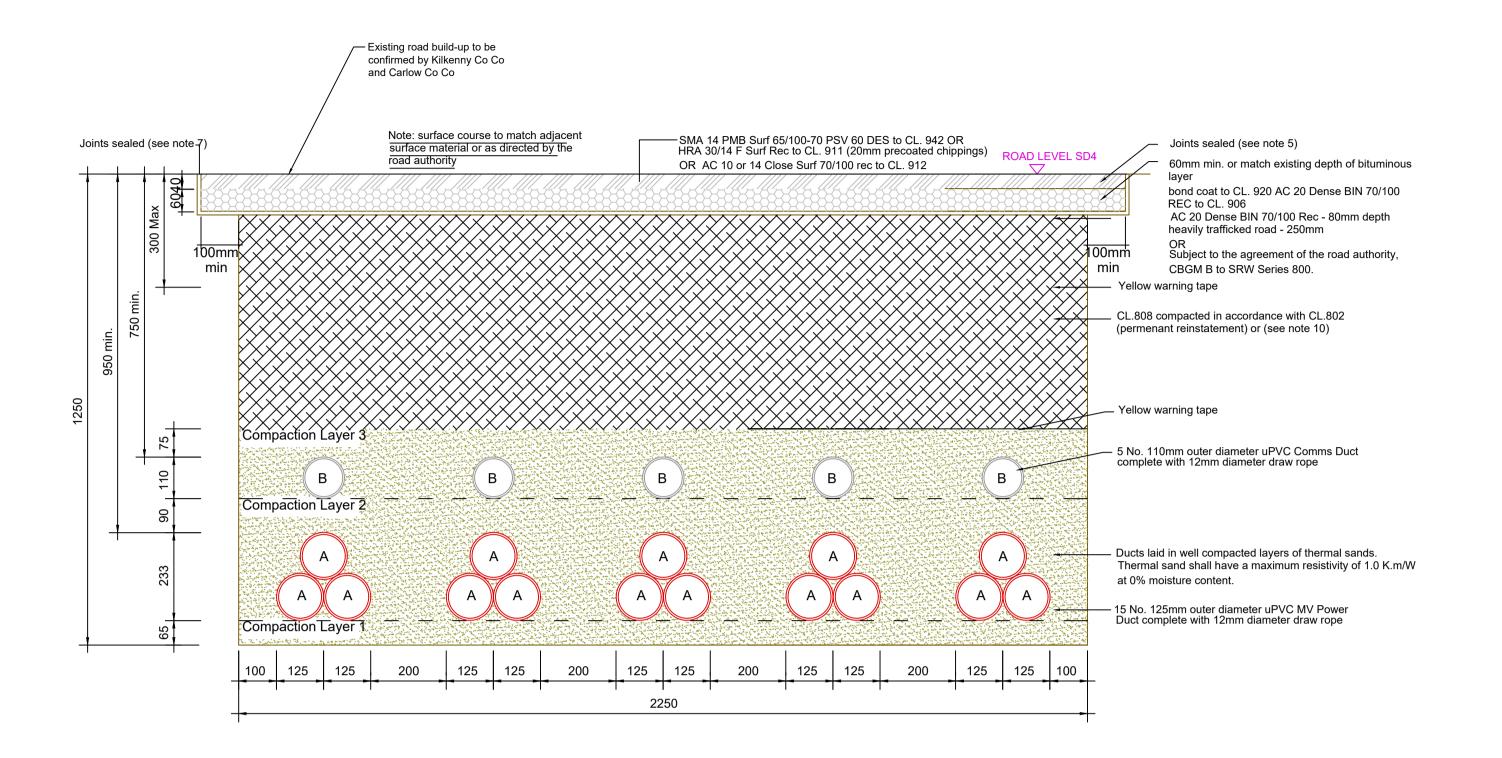
White Hill Wind Farm Electricity Substation & Electricity Line

FIGURE 7.03: TYPICAL PALISADE FENCE DETAIL


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Scale:	Date:		Revision No.:
(A3) 1:50	08/01/2025		REV 00
<u>Drawn By:</u>	Checked By:		Confirmed By:
EF	JB		SC



TYPICAL 110KV CABLE TRENCH DETAIL THROUGH ACCESS TRACKS SECTION Scale 1:10



MEDIUM VOLTAGE ELECTRICITY LINE TRENCH DETAIL THROUGH PUBLIC ROADWAY SECTION Scale 1:10

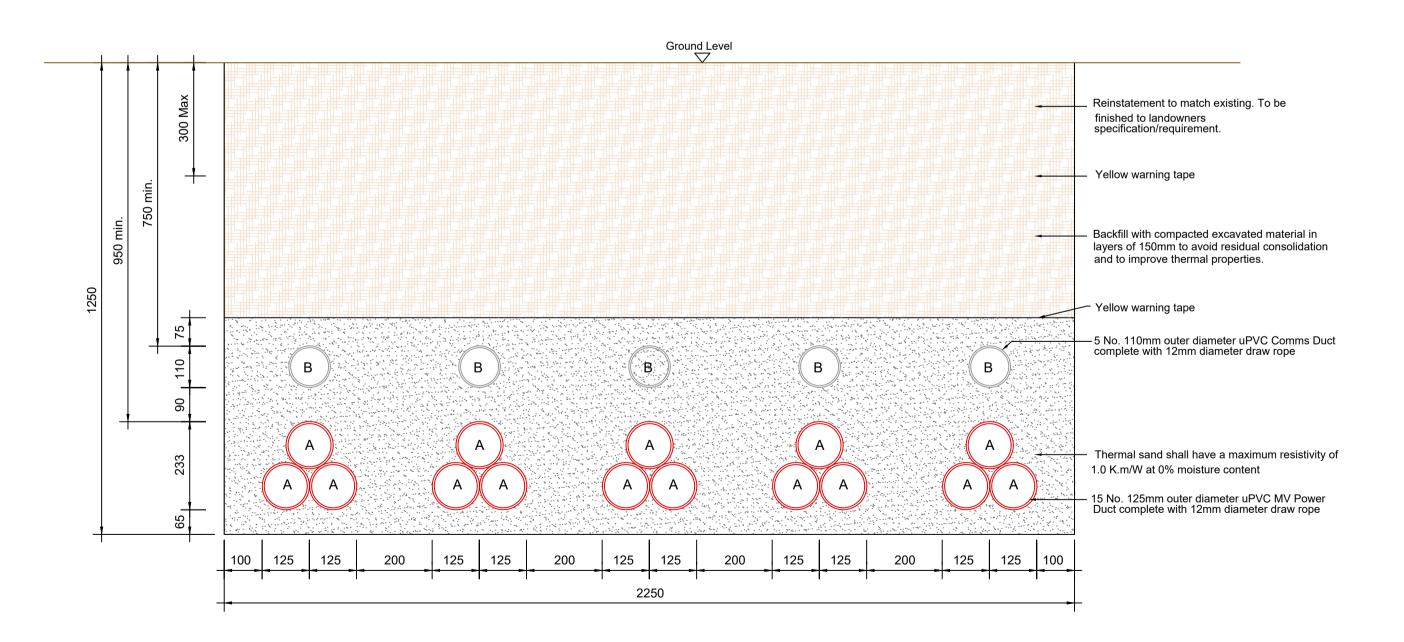

MEDIUM VOLTAGE ELECTRICITY LINE TRENCH DETAIL THROUGH OFF ROAD SECTION Scale 1:10

A = 125mm: Outer Diameter Power Duct,

B = 110mm: Outer Diameter Comms Duct

Notes:

- 1. All dimensions must be checked on site and not scaled from this drawing.
- 2. All dimensions in millimetres unless otherwise
- Dimensions may vary depending on site conditions.

Date:	Rev:	Description:	Drawn By
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Prepared By:




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WHITE HILL WIND LIMITED


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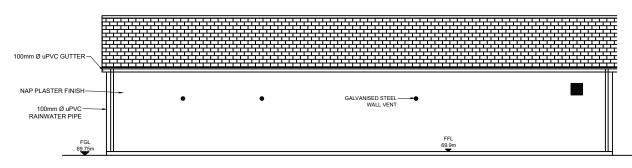
FIGURE 7.04: TYPICAL ELECTRICITY LINE TRENCH DETAIL

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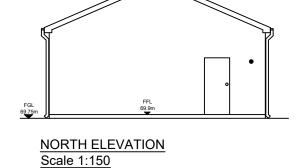







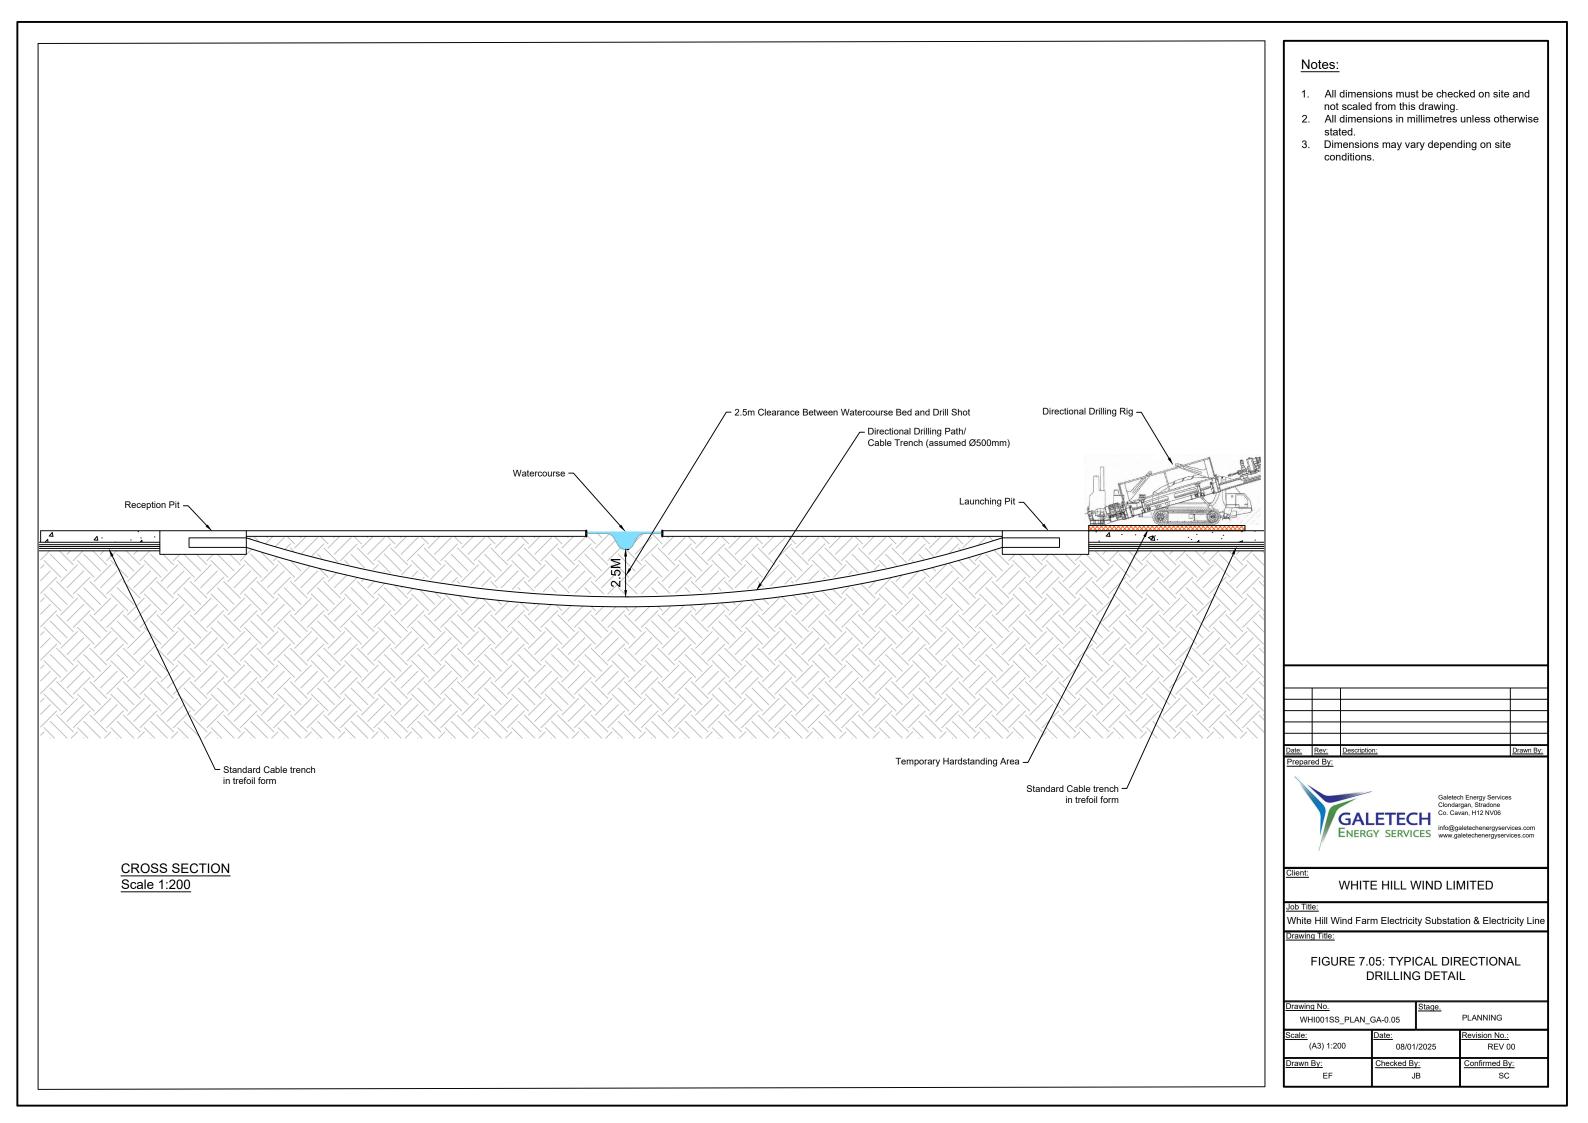


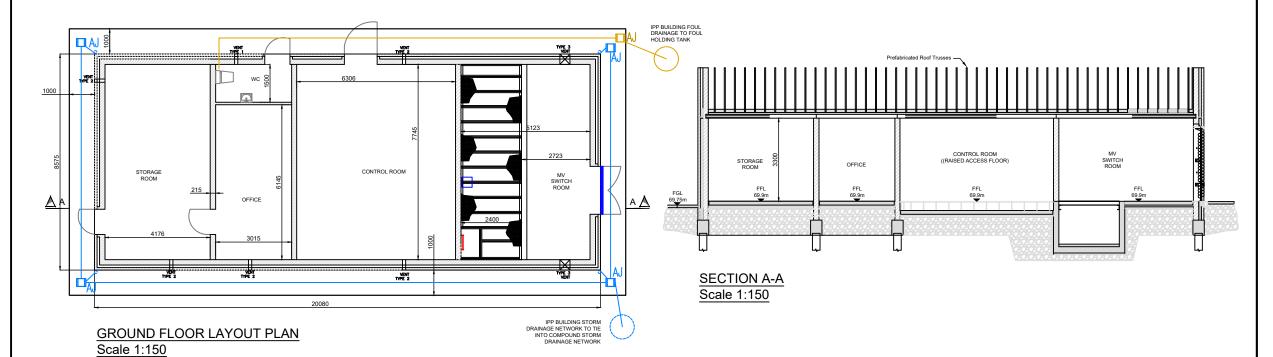WEST ELEVATION Scale 1:150



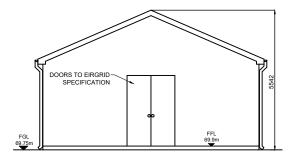


SOUTH ELEVATION Scale 1:150

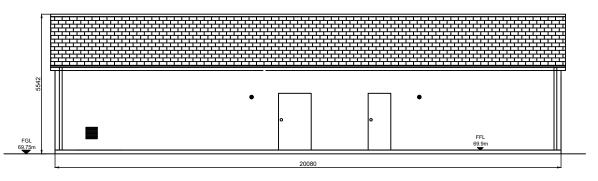

EAST ELEVATION Scale 1:150

- 1. All dimensions must be checked on site and not scaled from this drawing.
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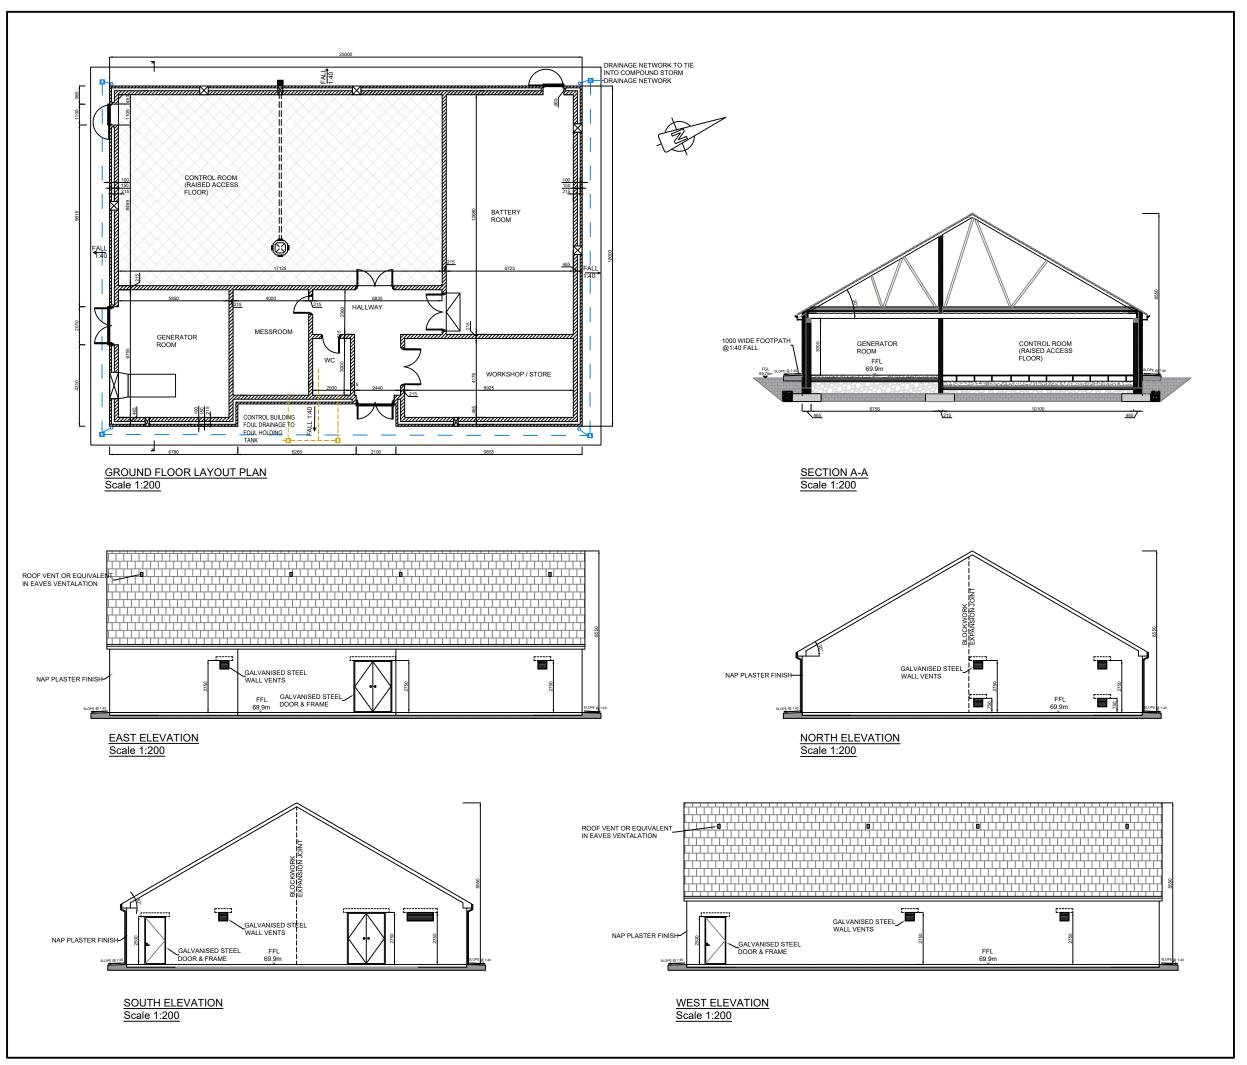
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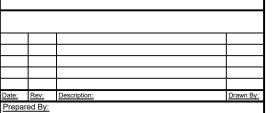
White Hill Wind Farm Electricity Substation & Electricity Line

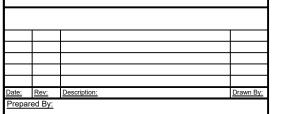FIGURE 7.06: TYPICAL INDEPENDENT POWER PROVIDER BUILDING PLAN / ELEVATION / SECTIONS

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FIGURE 7.07: TYPICAL EIRGRID BUILDING PLAN / ELEVATIONS / SECTIONS

Drawing No. WHI001SS_PLAN_0	GA-0.07	Stage.	PLANNING
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